

1 BASEMENT ELECTRICAL PLAN - 'A' AND 'B' WINGS

EB.1

0' 4' 8' 16'

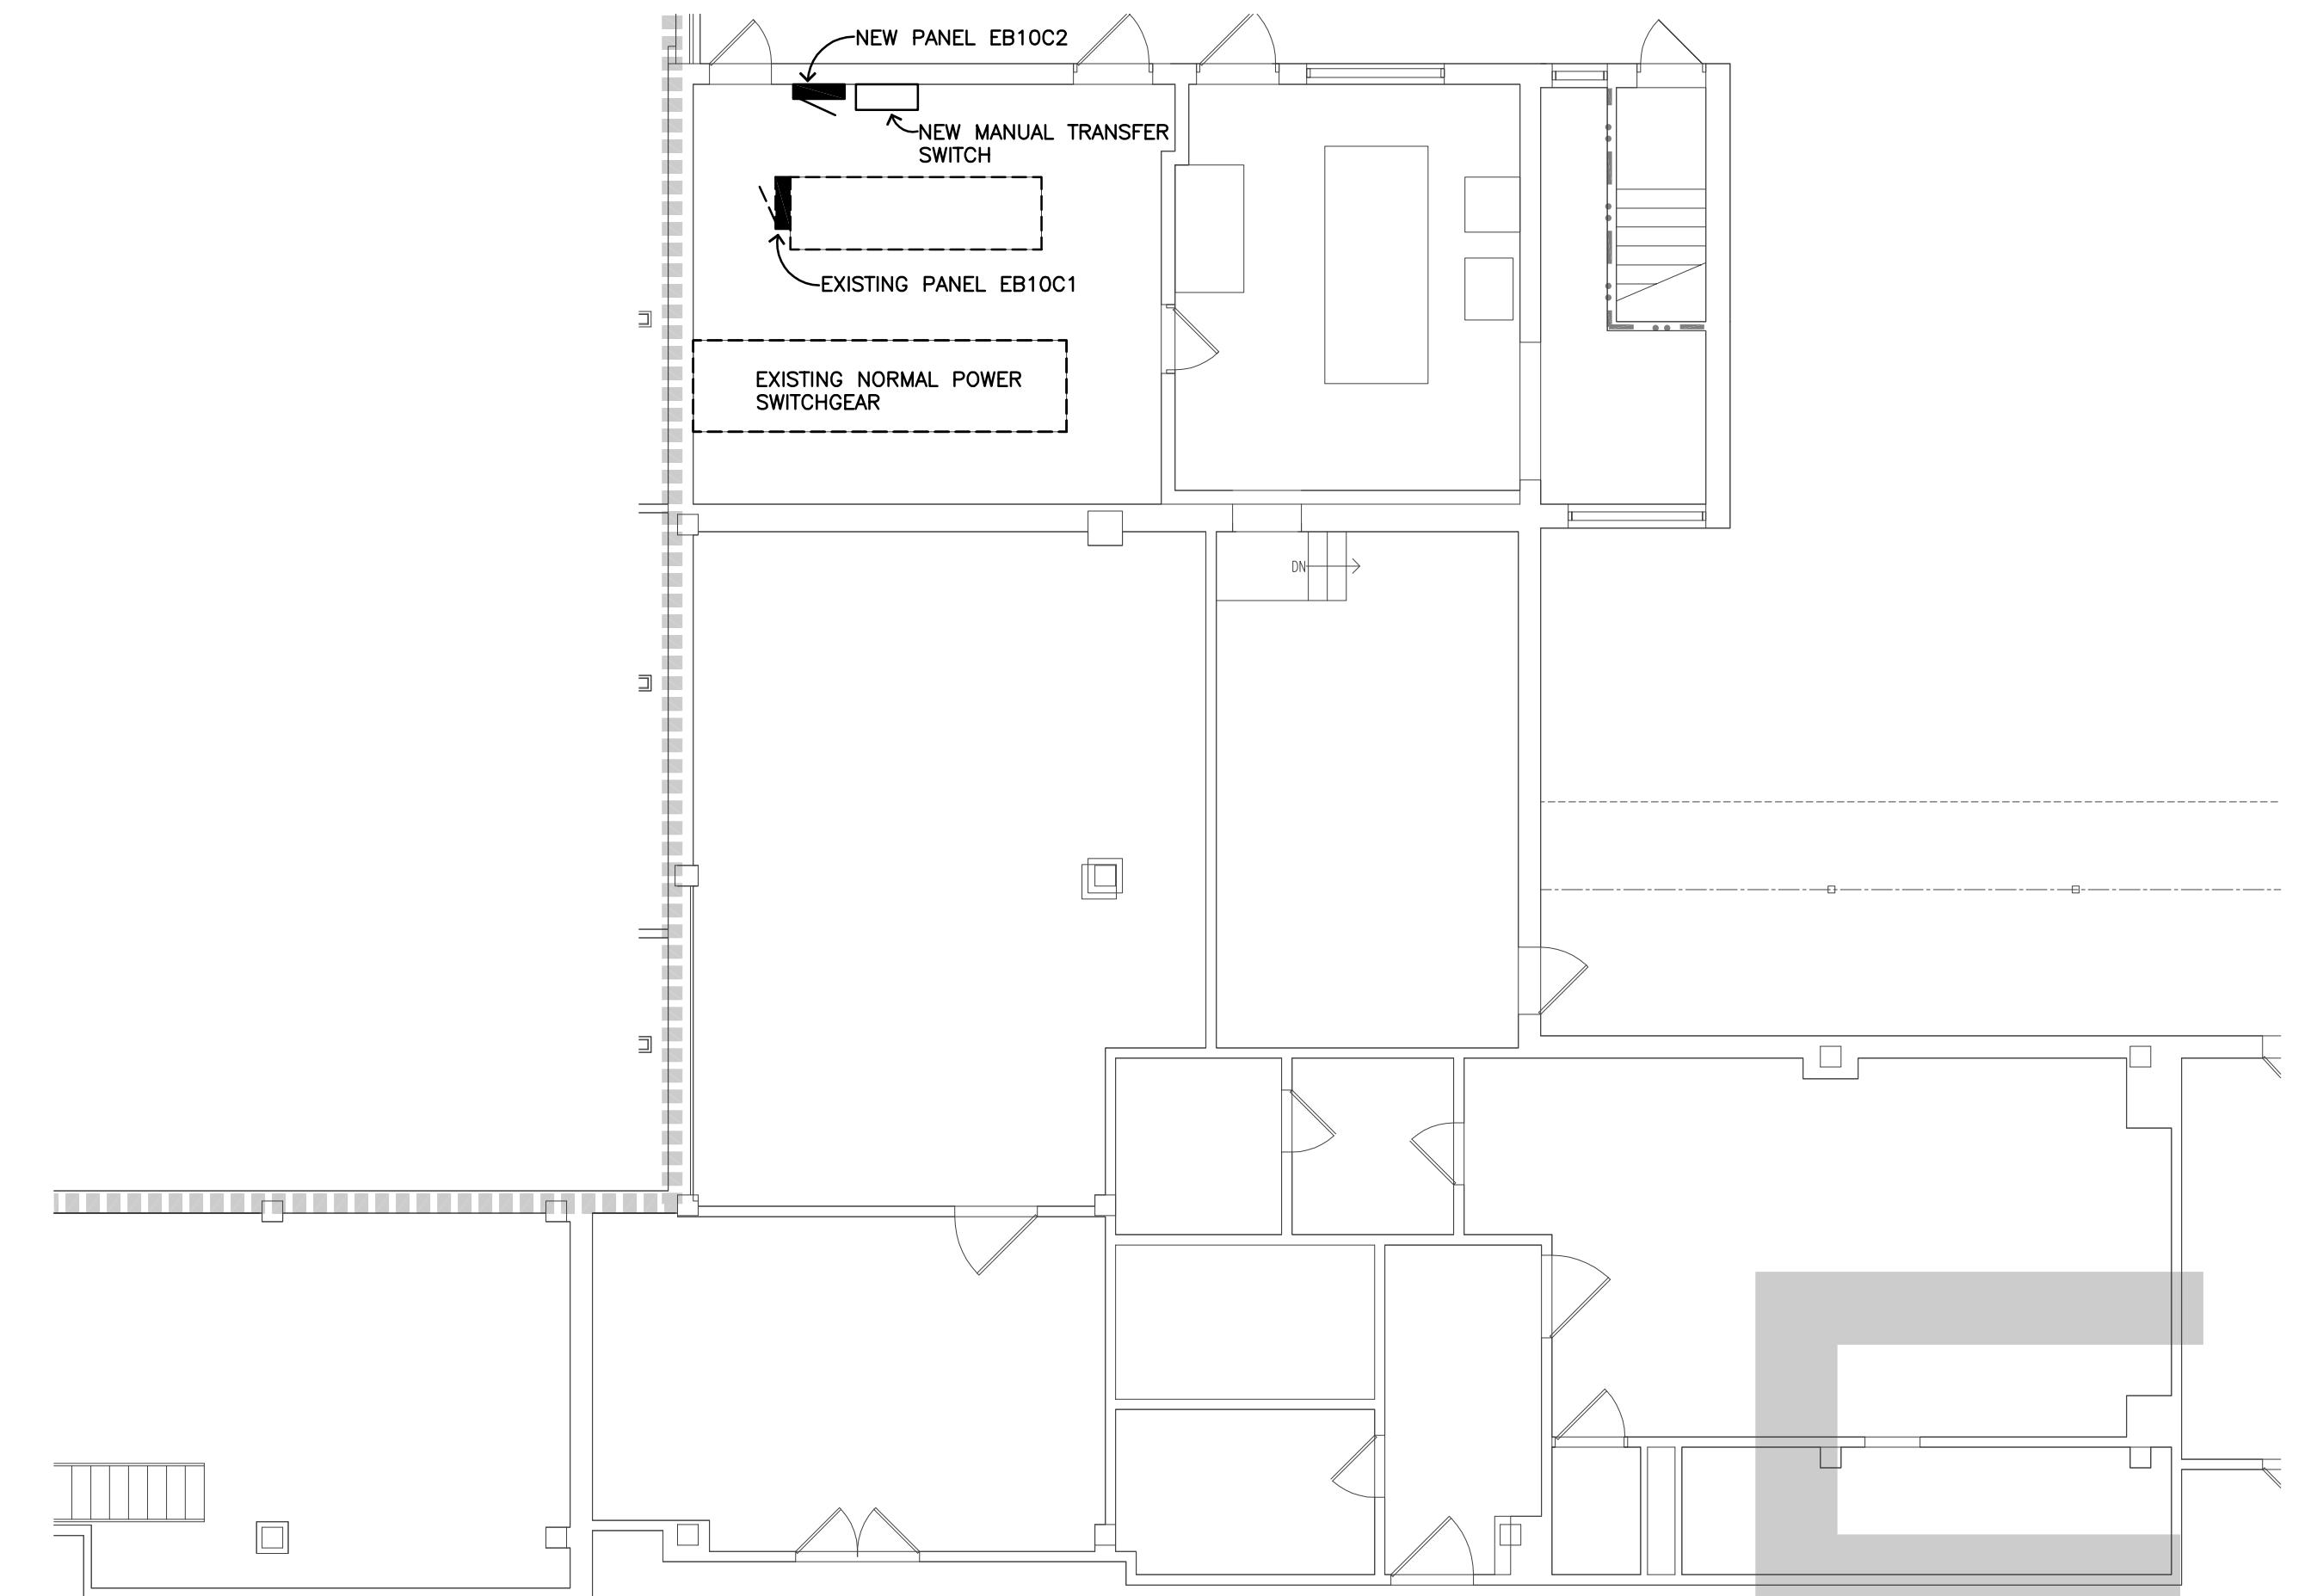
ELECTRICAL SYMBOLS LEGEND	
SYMBOLS	DESCRIPTION
DASHED LINES	INDICATE EXISTING FIXTURES, DEVICES, OR EQUIPMENT
RECESSED FLUORESCENT	
CEILING SURFACE MOUNTED LIGHT FIXTURE	
SURFACE MOUNTED LIGHT FIXTURE	
CEILING EXIT SIGN, SHADED SIDE INDICATES LIGHTED FACE	
CEILING MOUNTED RECESSED SPEAKER	
SMOKE DETECTOR	
NURSE CALL CEILING LIGHT	
WIRELESS ACCESS ROUTER	
PANEL BOARD	
NON FUSED DISCONNECT	
FUSED DISCONNECT	
DISCONNECT	
NOTE IDENTIFICATION	
— ONE HOUR FIRE BARRIER	
— TWO HOUR FIRE BARRIER	
— ONE HOUR FIRE/SMOKE BARRIER	
— TWO HOUR FIRE/SMOKE BARRIER	

PHASING NOTES:

- ALL WORK IN FIRST FLOOR SPACES EXCEPT BB-102 AND 1407 SHALL OCCUR DURING OVERTIME AND/OR WEEKEND HOURS. SPACES SHALL BE CLEANED AND RETURNED TO WORKERS IN A TIMELY MANNER BY THE VA STAFF DURING NORMAL BUSINESS HOURS.
- CAREFULLY COORDINATE WITH THE OWNER A MINIMUM OF 2 WEEKS IN ADVANCE PRIOR TO WORK COMMENCING.
- REFER TO SHEET X1 GENERAL NOTES AND ARCHITECTURAL SHEETS FOR SPECIFIC PHASING INFORMATION FOR INDIVIDUAL SPACES.

PLAN NOTES:


- DISCONNECT AND REMOVE EXISTING LIGHT FIXTURE. FIXTURE TO BE REINSTALLED WHERE SHOWN UPON COMPLETION OF CEILING INSTALLATION.
- DISCONNECT AND REMOVE EXISTING SPEAKER. SPEAKER TO BE REINSTALLED UPON COMPLETION OF CEILING INSTALLATION.
- EXPOSED STRUCTURE IN ROOM, DISCONNECT, REMOVE, AND REINSTALL EXISTING LIGHT FIXTURES AS REQUIRED. VERIFY WORK REQUIRED WITH MECHANICAL CONTRACTOR.
- CONDUIT MUST NOT BE ROUTED WITHIN CLEAN STORAGE BB-15.



3 BASEMENT ELECTRICAL PLAN - 'E' WING

EB.1

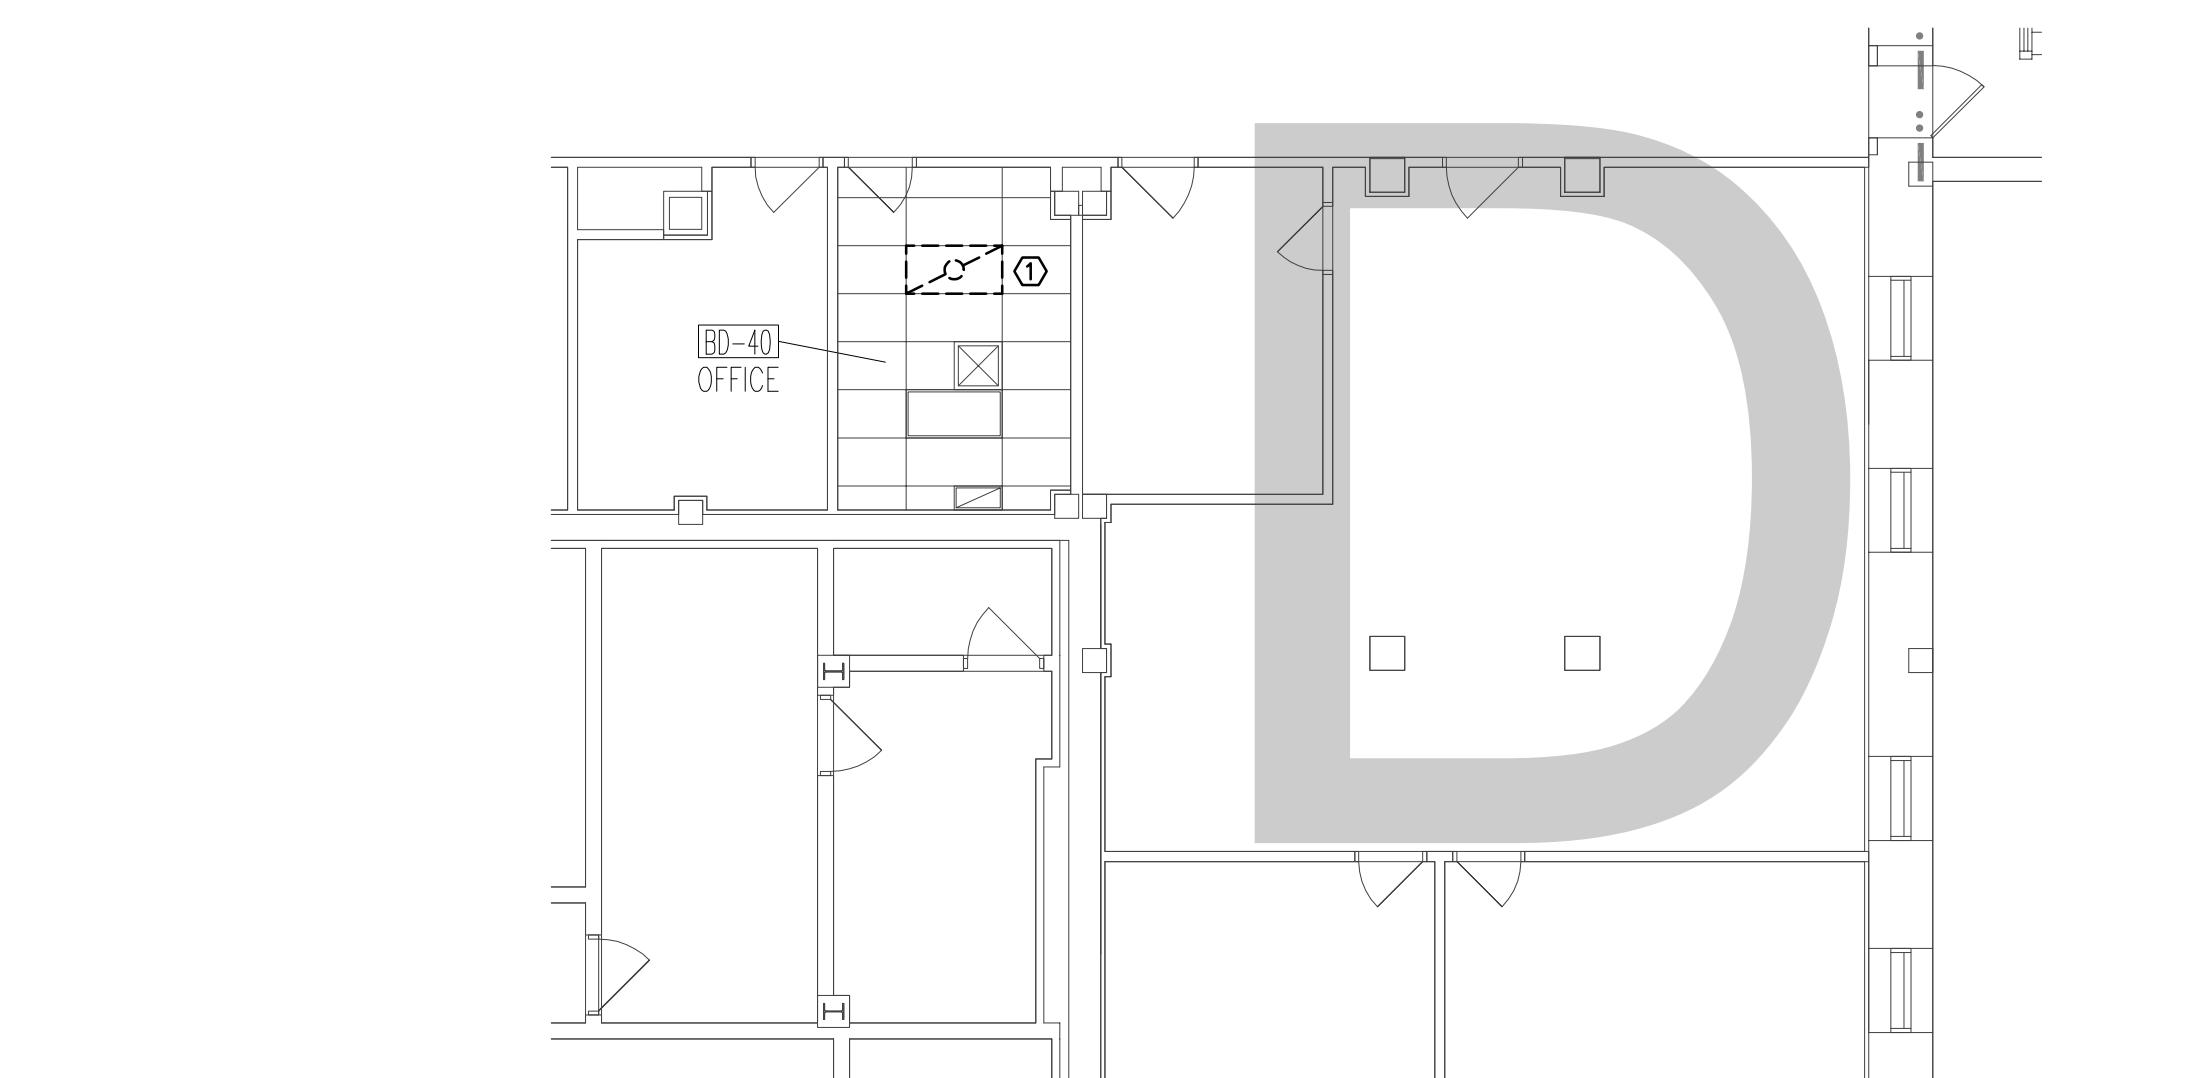0' 4' 8' 16'




2 BASEMENT ELECTRICAL PLAN - 'D' WING

EB.1

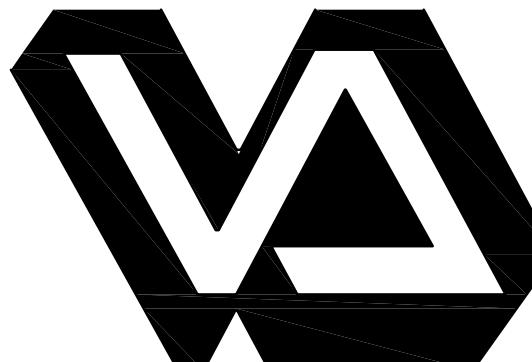0' 4' 8' 16'

Revisions	Date
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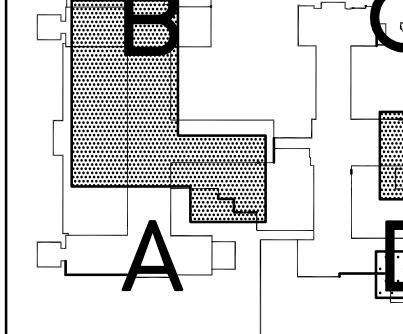


Dept. of Veterans Affairs
Health Care System
2101 Elm Street North
Fargo, ND 58102



IMAGE GROUP INC.
403 CENTER AVENUE, SUITE 300
MOORHEAD, MN 56560

IMAGE GROUP INC., Architecture & Interiors
OBERMILLER NELSON ENGINEERING, Mechanical Engineers
MBN ENGINEERING, Electrical Engineers



Project No.	Contract No.
437-13-103	VA263-P-1217 VA263-C

Building No.
1, 9, 46

AutoCAD File Name
13-027 EB1.dwg

Designed By
MB


Checked By
MB

Drawn By
TP

Location
FARGO VA HEALTH CARE SYSTEM
FARGO, ND

Project Title	Drawing Title
IMPROVE SPS/LOGISTICS STORAGE ROOM HVAC SYSTEMS	BASEMENT ELECTRICAL PLAN - 'A', 'B', 'D' AND 'E' WINGS

Date	July 5, 2013
Scale:	1/8" = 1'-0"
Drawing No.	EB.1
Dwg. 15 of 21	Department of Veterans Affairs

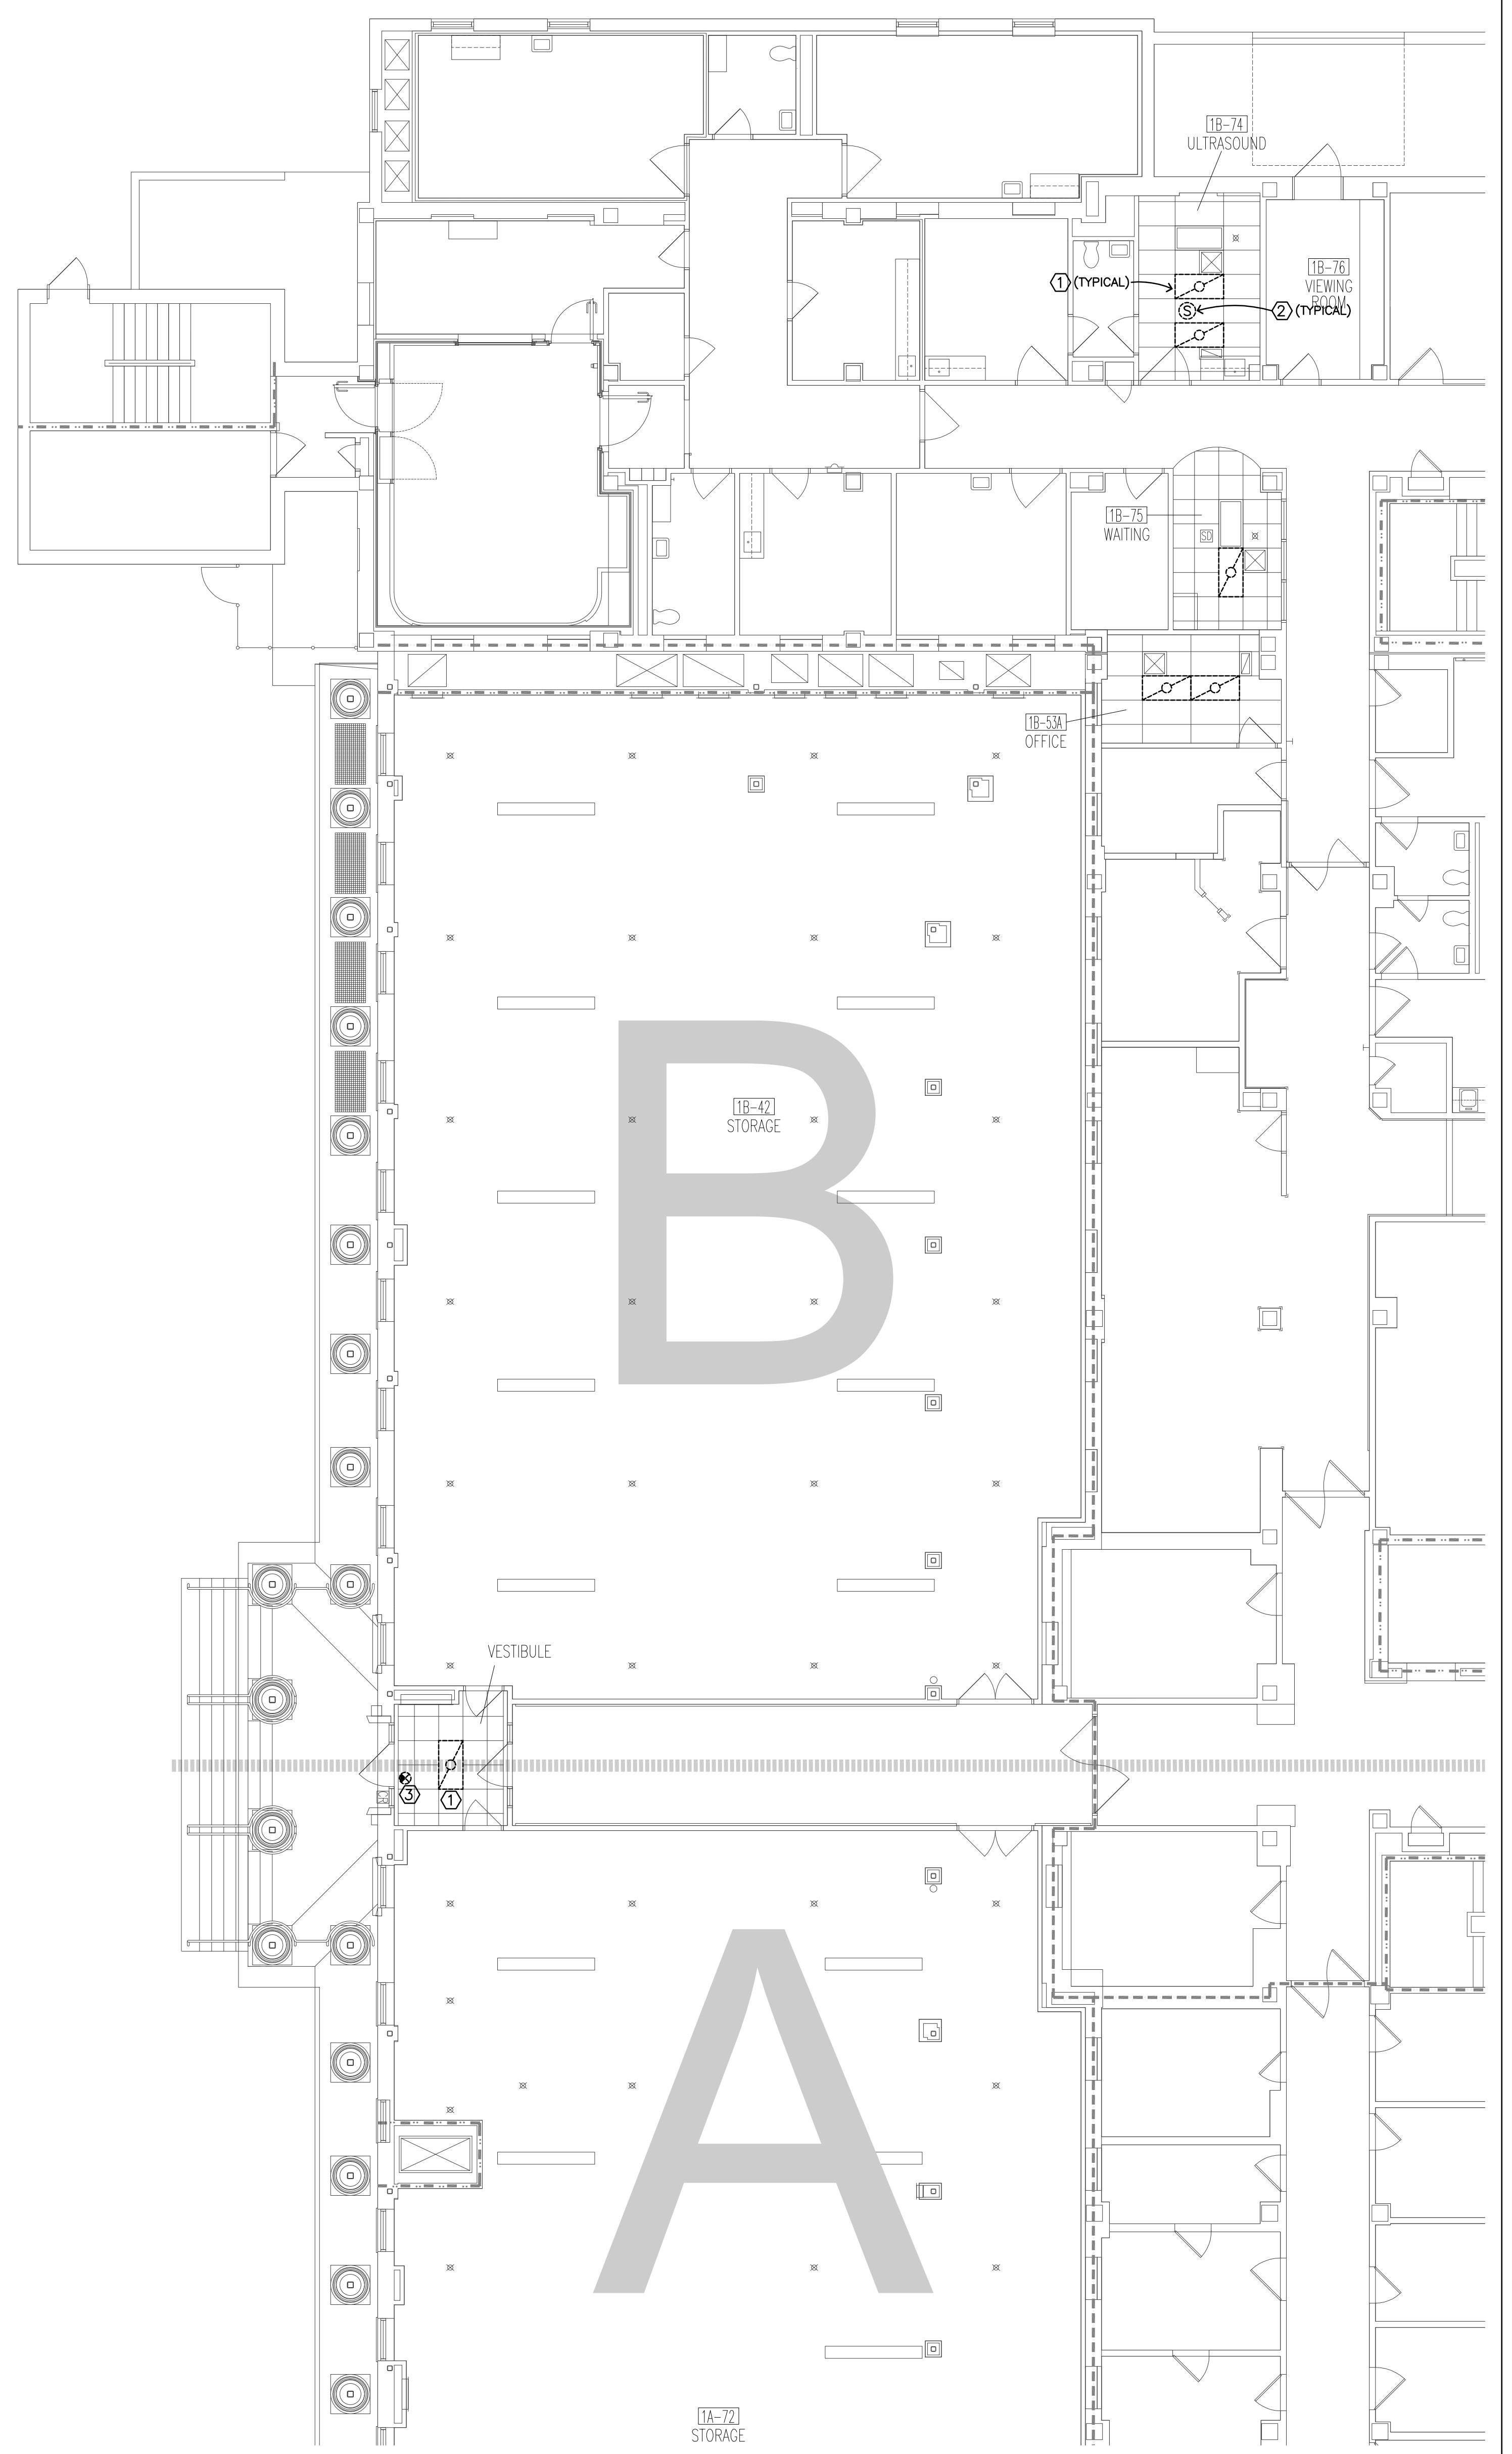

1 FIRST FLOOR ELECTRICAL PLAN - 'A' AND 'B' WINGS

A:\Projects\13-027\Drawings\13-027_E1_2.dwg Jul 09, 2013 - 6:41pm

Revisions	
	Date




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2101 Elm Street North
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IMAGE GROUP INC.
403 CENTER AVENUE, SUITE 300
MOORHEAD, MN 56560

IMAGE GROUP INC., Architecture & Interiors
OBERMILLER NELSON ENGINEERING, Mechanical Engineers
MBN ENGINEERING, Electrical Engineers



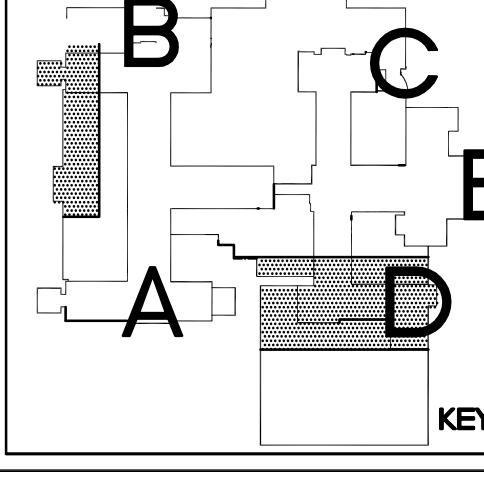Drawing Title:
FIRST FLOOR ELECTRICAL PLAN - 'A', 'B' AND 'D' WINGS

Project Title:
**IMPROVE SPS/LOGISTICS
STORAGE ROOM HVAC SYSTEMS**

Date:
JULY 5, 2013

Scale:
1/8" = 1'-0"

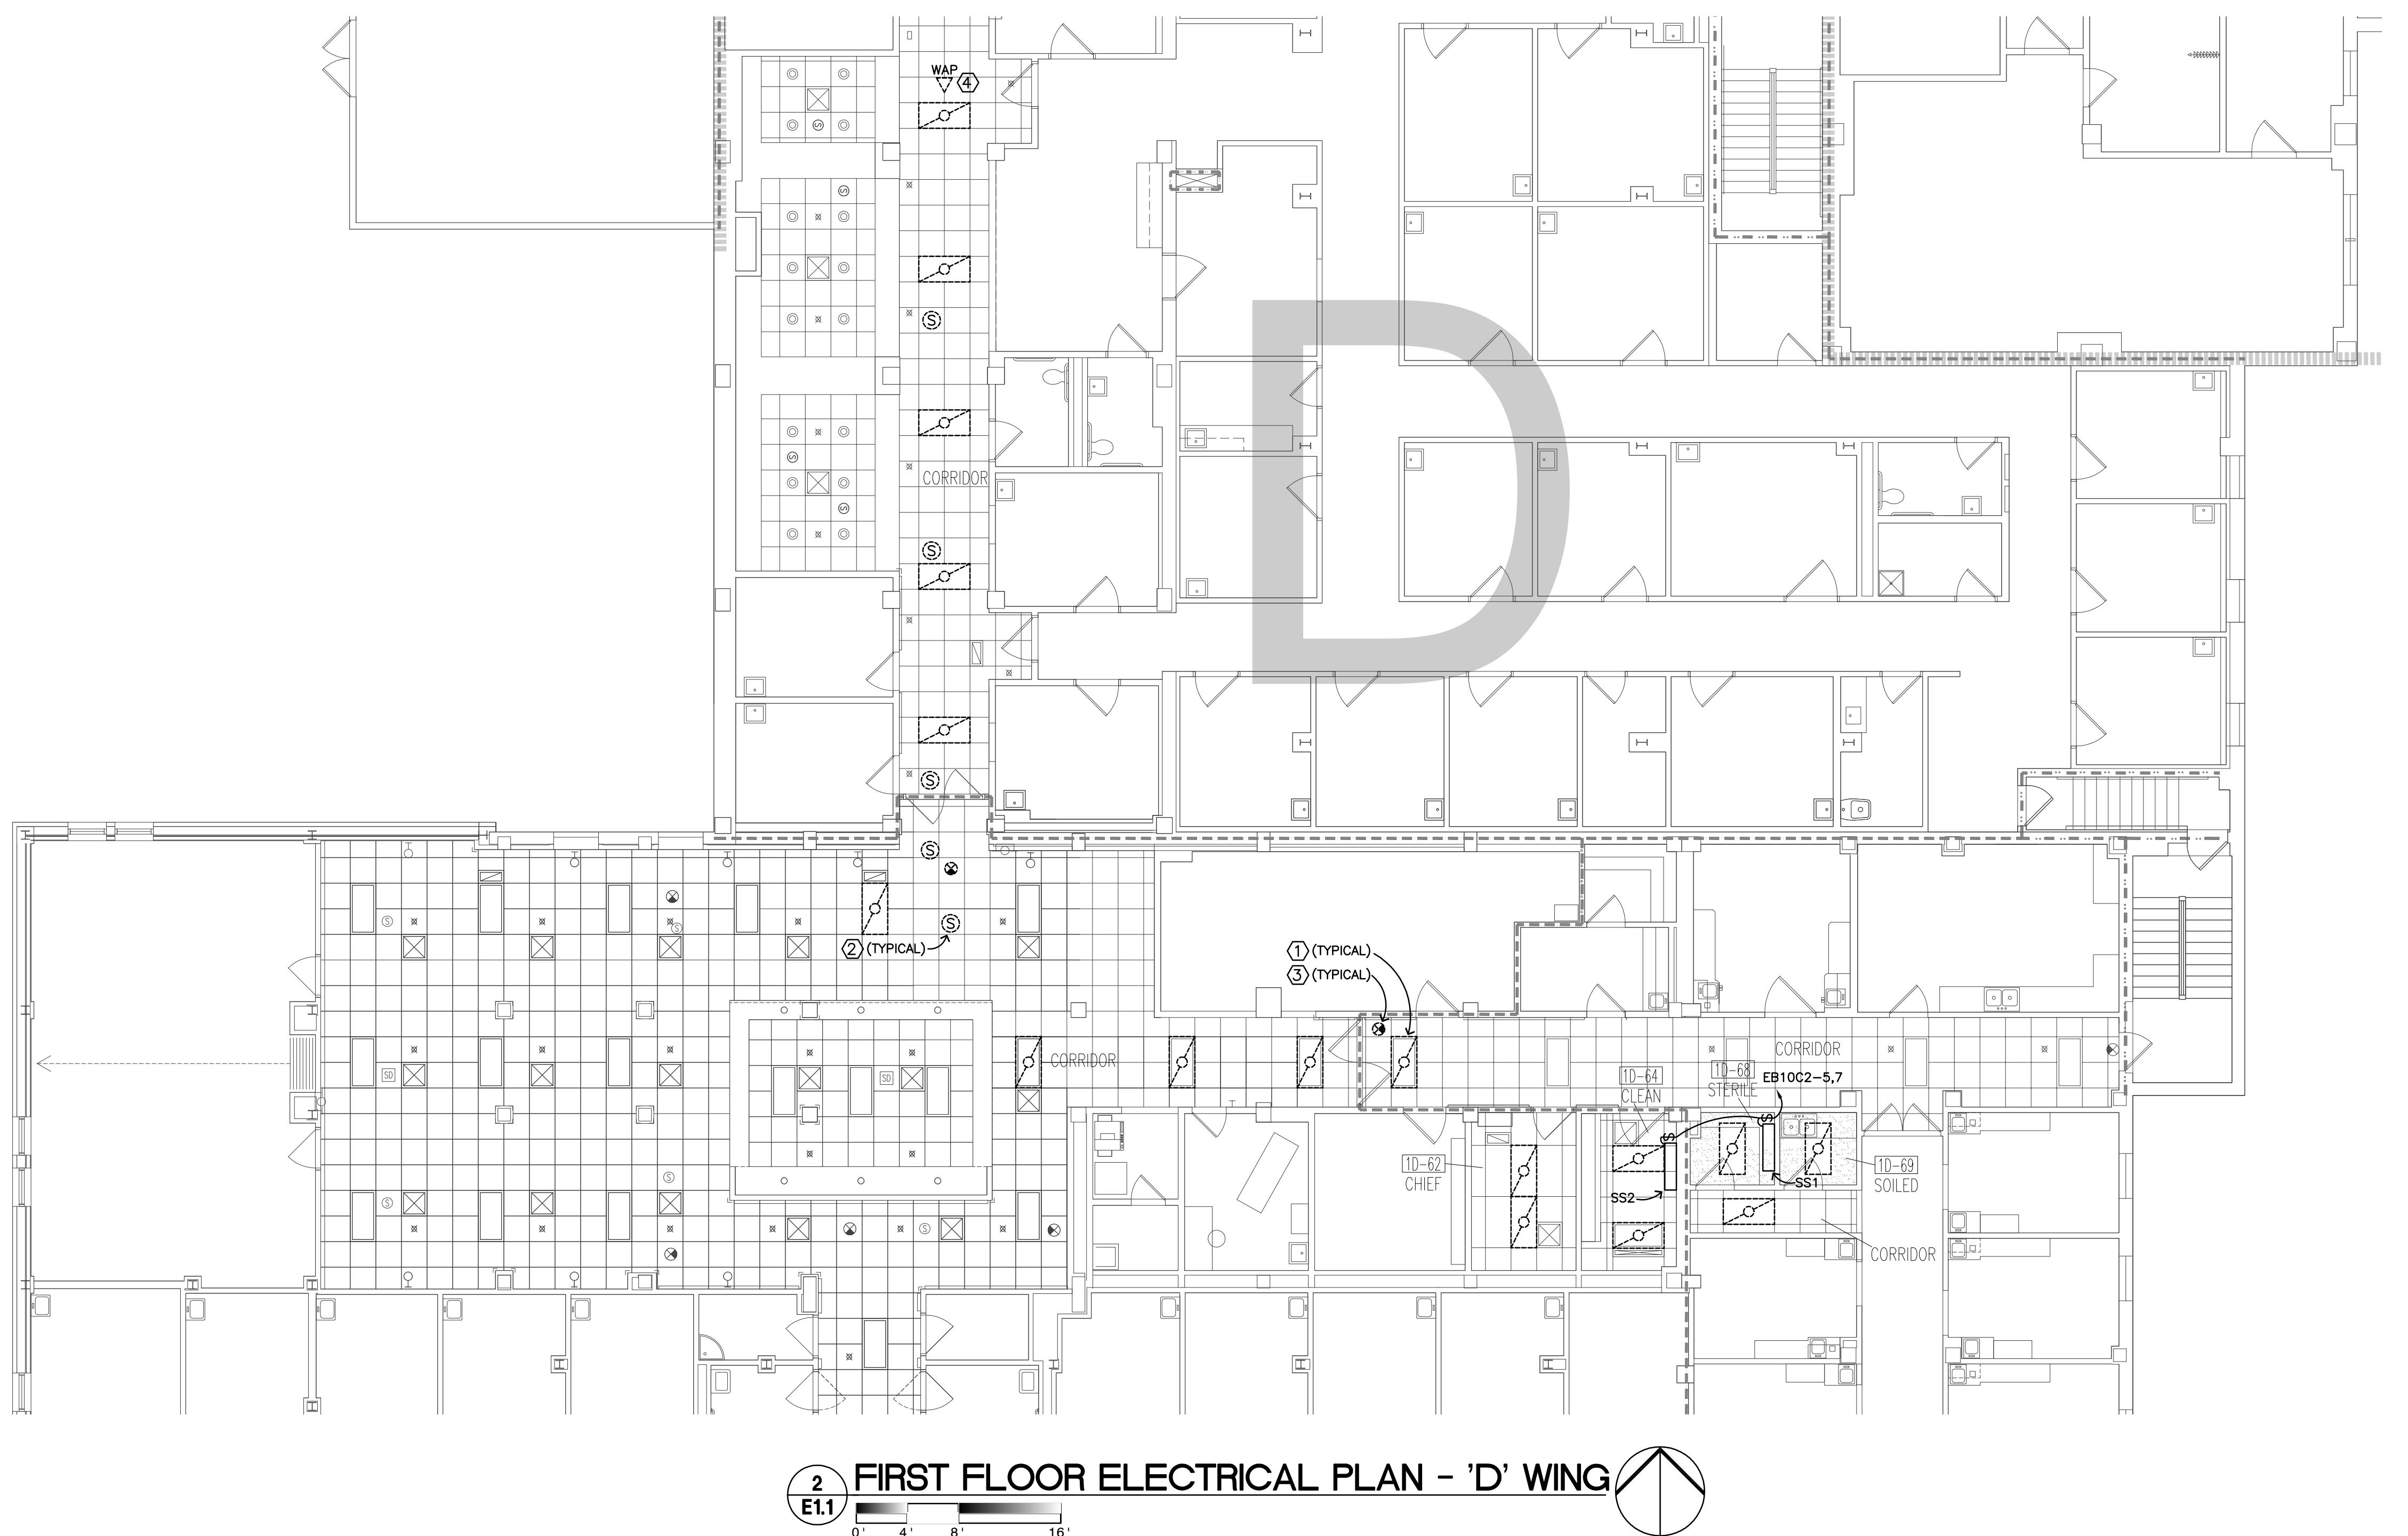
Designed By:
MB

Checked By:
MB

Drawn By:
TP

Drawing No.:
E1.1


Dwg. 16 of 21



2 FIRST FLOOR ELECTRICAL PLAN - 'D' WING

E1.1 0' 4' 8' 16'

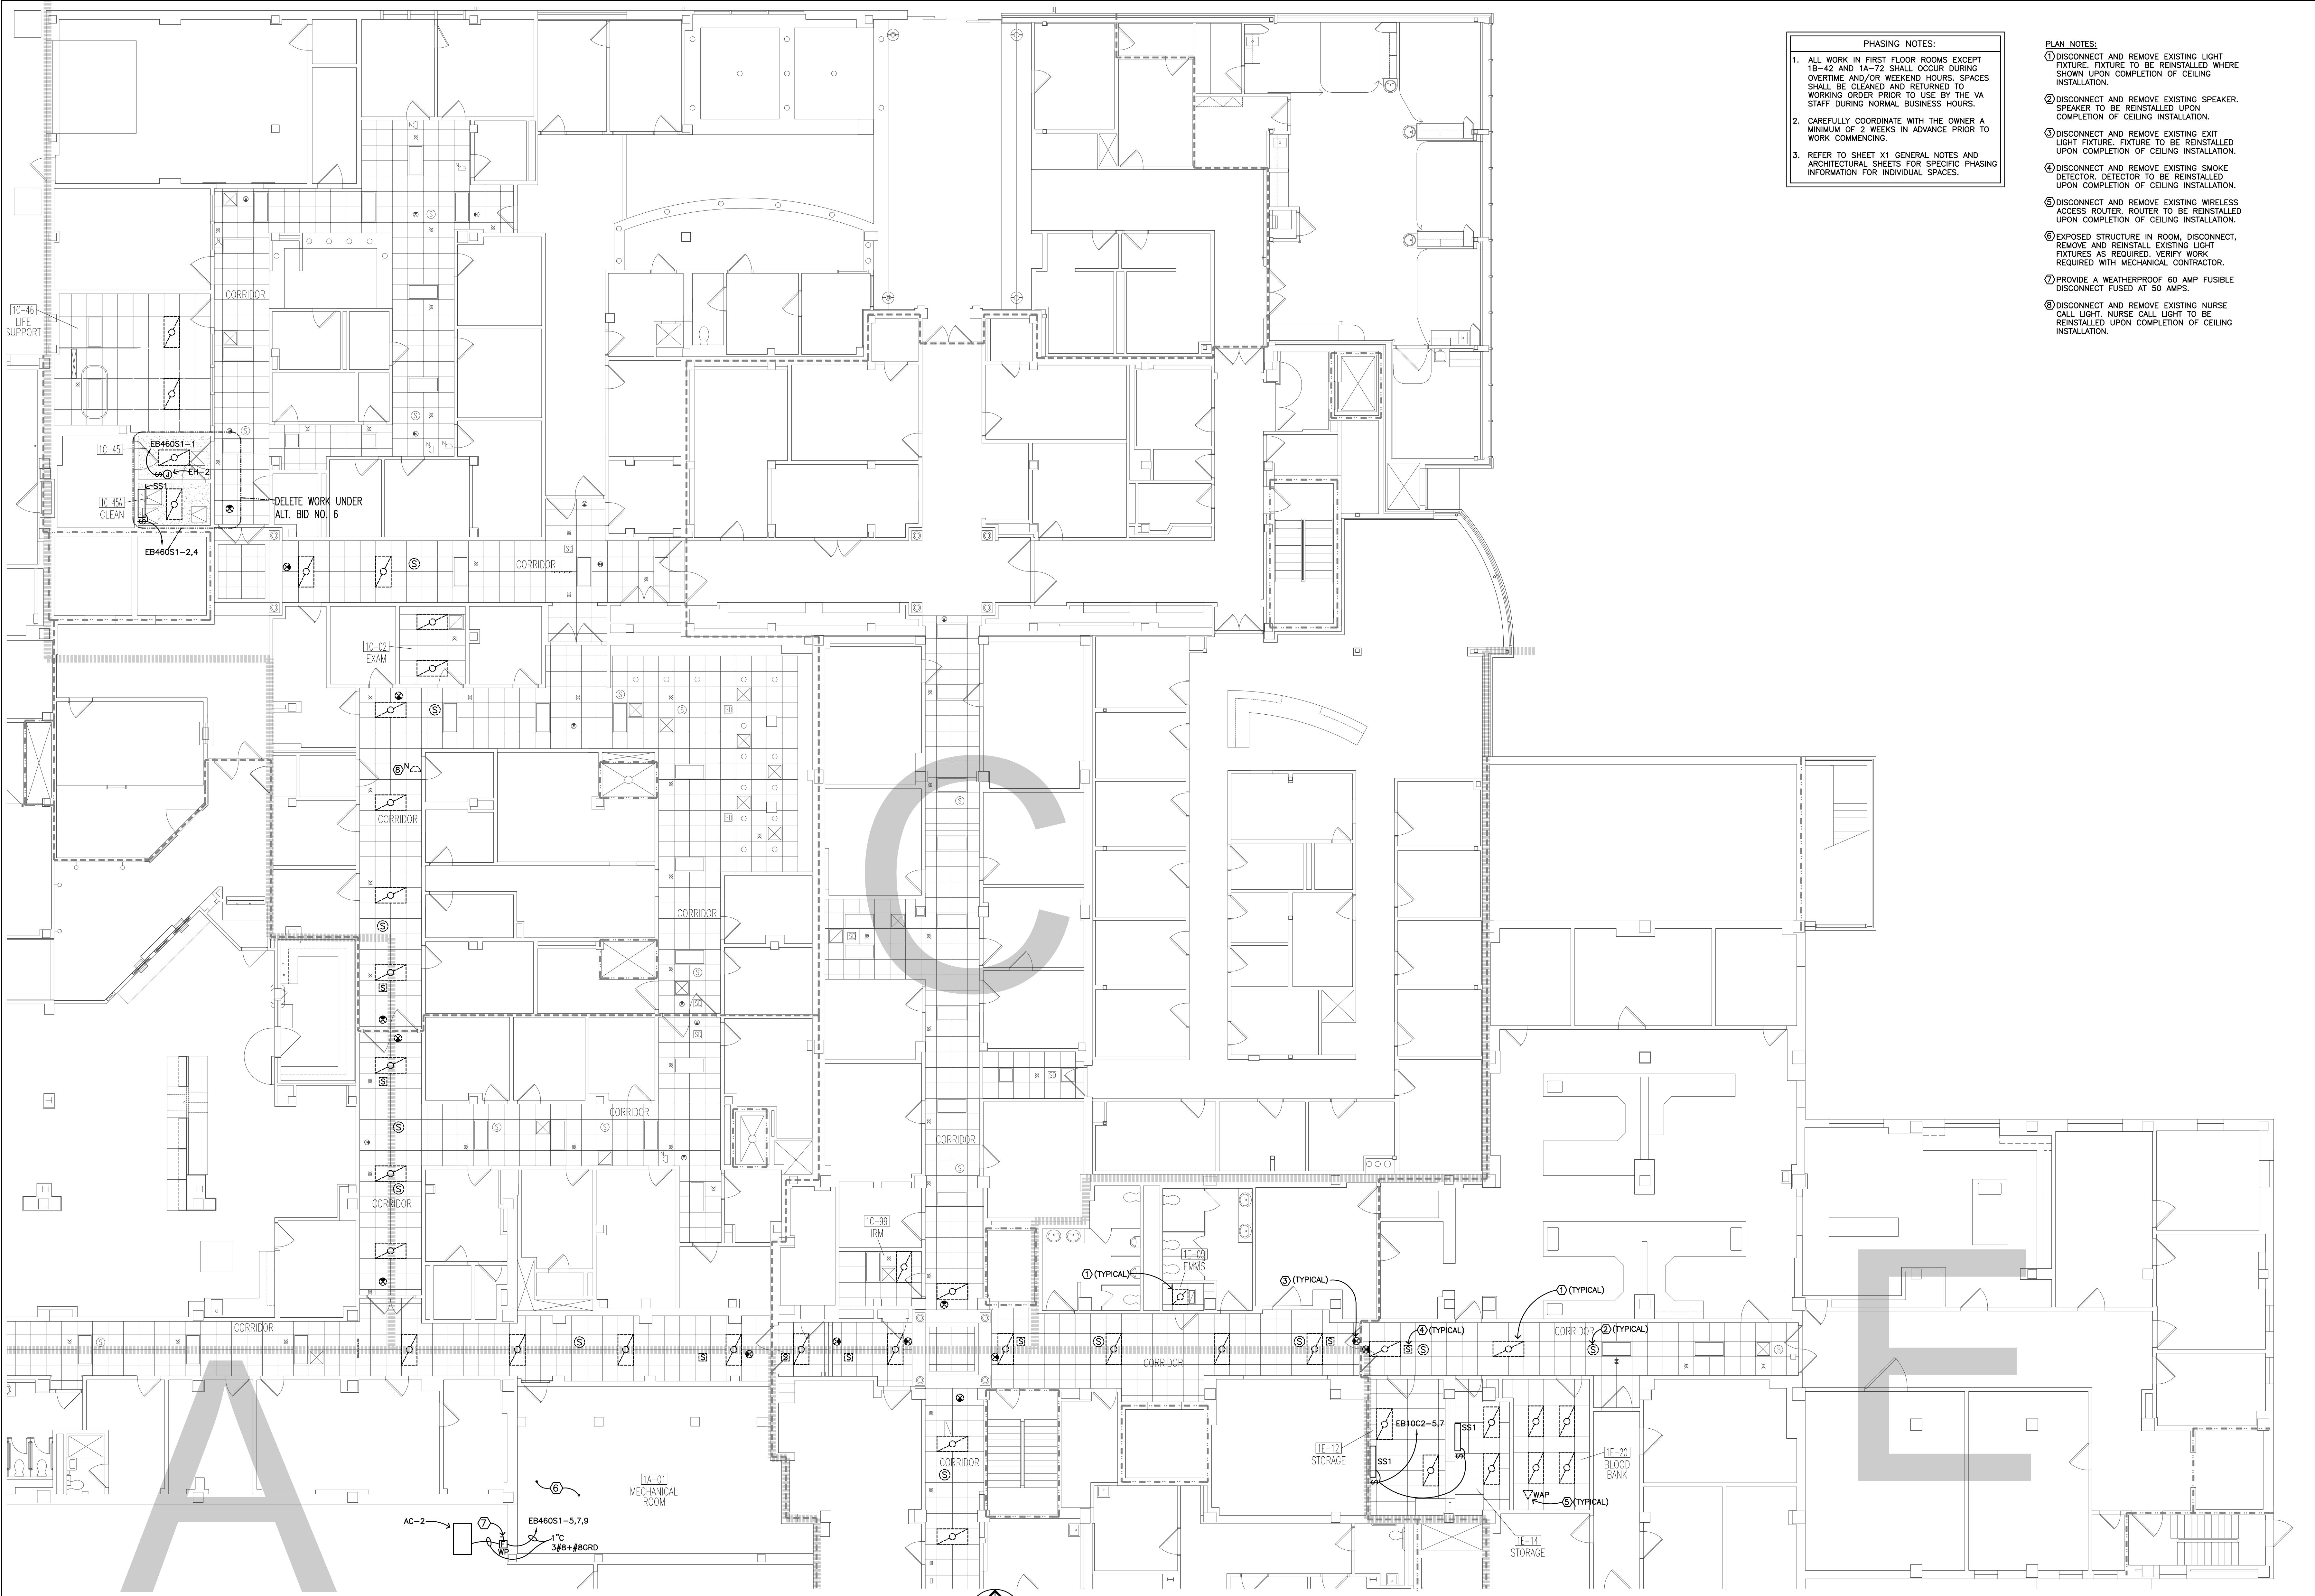- PHASING NOTES:
1. ALL WORK IN FIRST FLOOR ROOMS EXCEPT THE VESTIBULE, HALLS, AND OFFICES SHALL BE CLEARED AND RETURNED TO WORKING ORDER PRIOR TO USE BY THE VA STAFF DURING NORMAL BUSINESS HOURS.
 2. CAREFULLY COORDINATE WITH THE OWNER A MINIMUM OF 30 DAYS IN ADVANCE PRIOR TO WORK COMMENCING.
 3. REFER TO SHEET X1 GENERAL NOTES AND ARCHITECTURAL SHEETS FOR SPECIFIC PHASING INFORMATION FOR INDIVIDUAL SPACES.
- PLAN NOTES:
- ① DISCONNECT AND REMOVE EXISTING LIGHT FIXTURE, FIXTURE TO BE REINSTALLED WHERE SHOWN UPON COMPLETION OF CEILING INSTALLATION.
 - ② DISCONNECT AND REMOVE EXISTING SPEAKER. SPEAKER TO BE REINSTALLED UPON COMPLETION OF CEILING INSTALLATION.
 - ③ DISCONNECT AND REMOVE EXISTING EXIT LIGHT FIXTURE, FIXTURE TO BE REINSTALLED UPON COMPLETION OF CEILING INSTALLATION.
 - ④ ACCESS ROUTES ROUTE TO BE REINSTALLED UPON COMPLETION OF CEILING INSTALLATION.



1
E12
FIRST FLOOR ELECTRICAL PLAN - 'A', 'C', AND 'E' WINGS

Revisions	Date

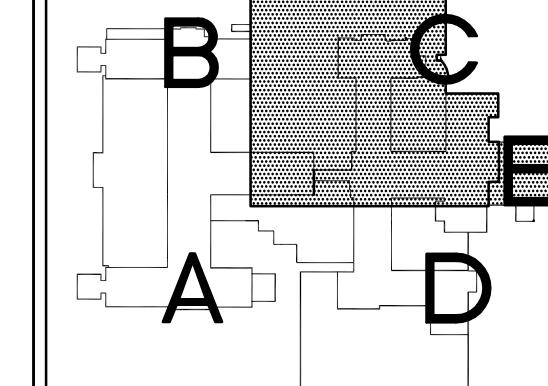


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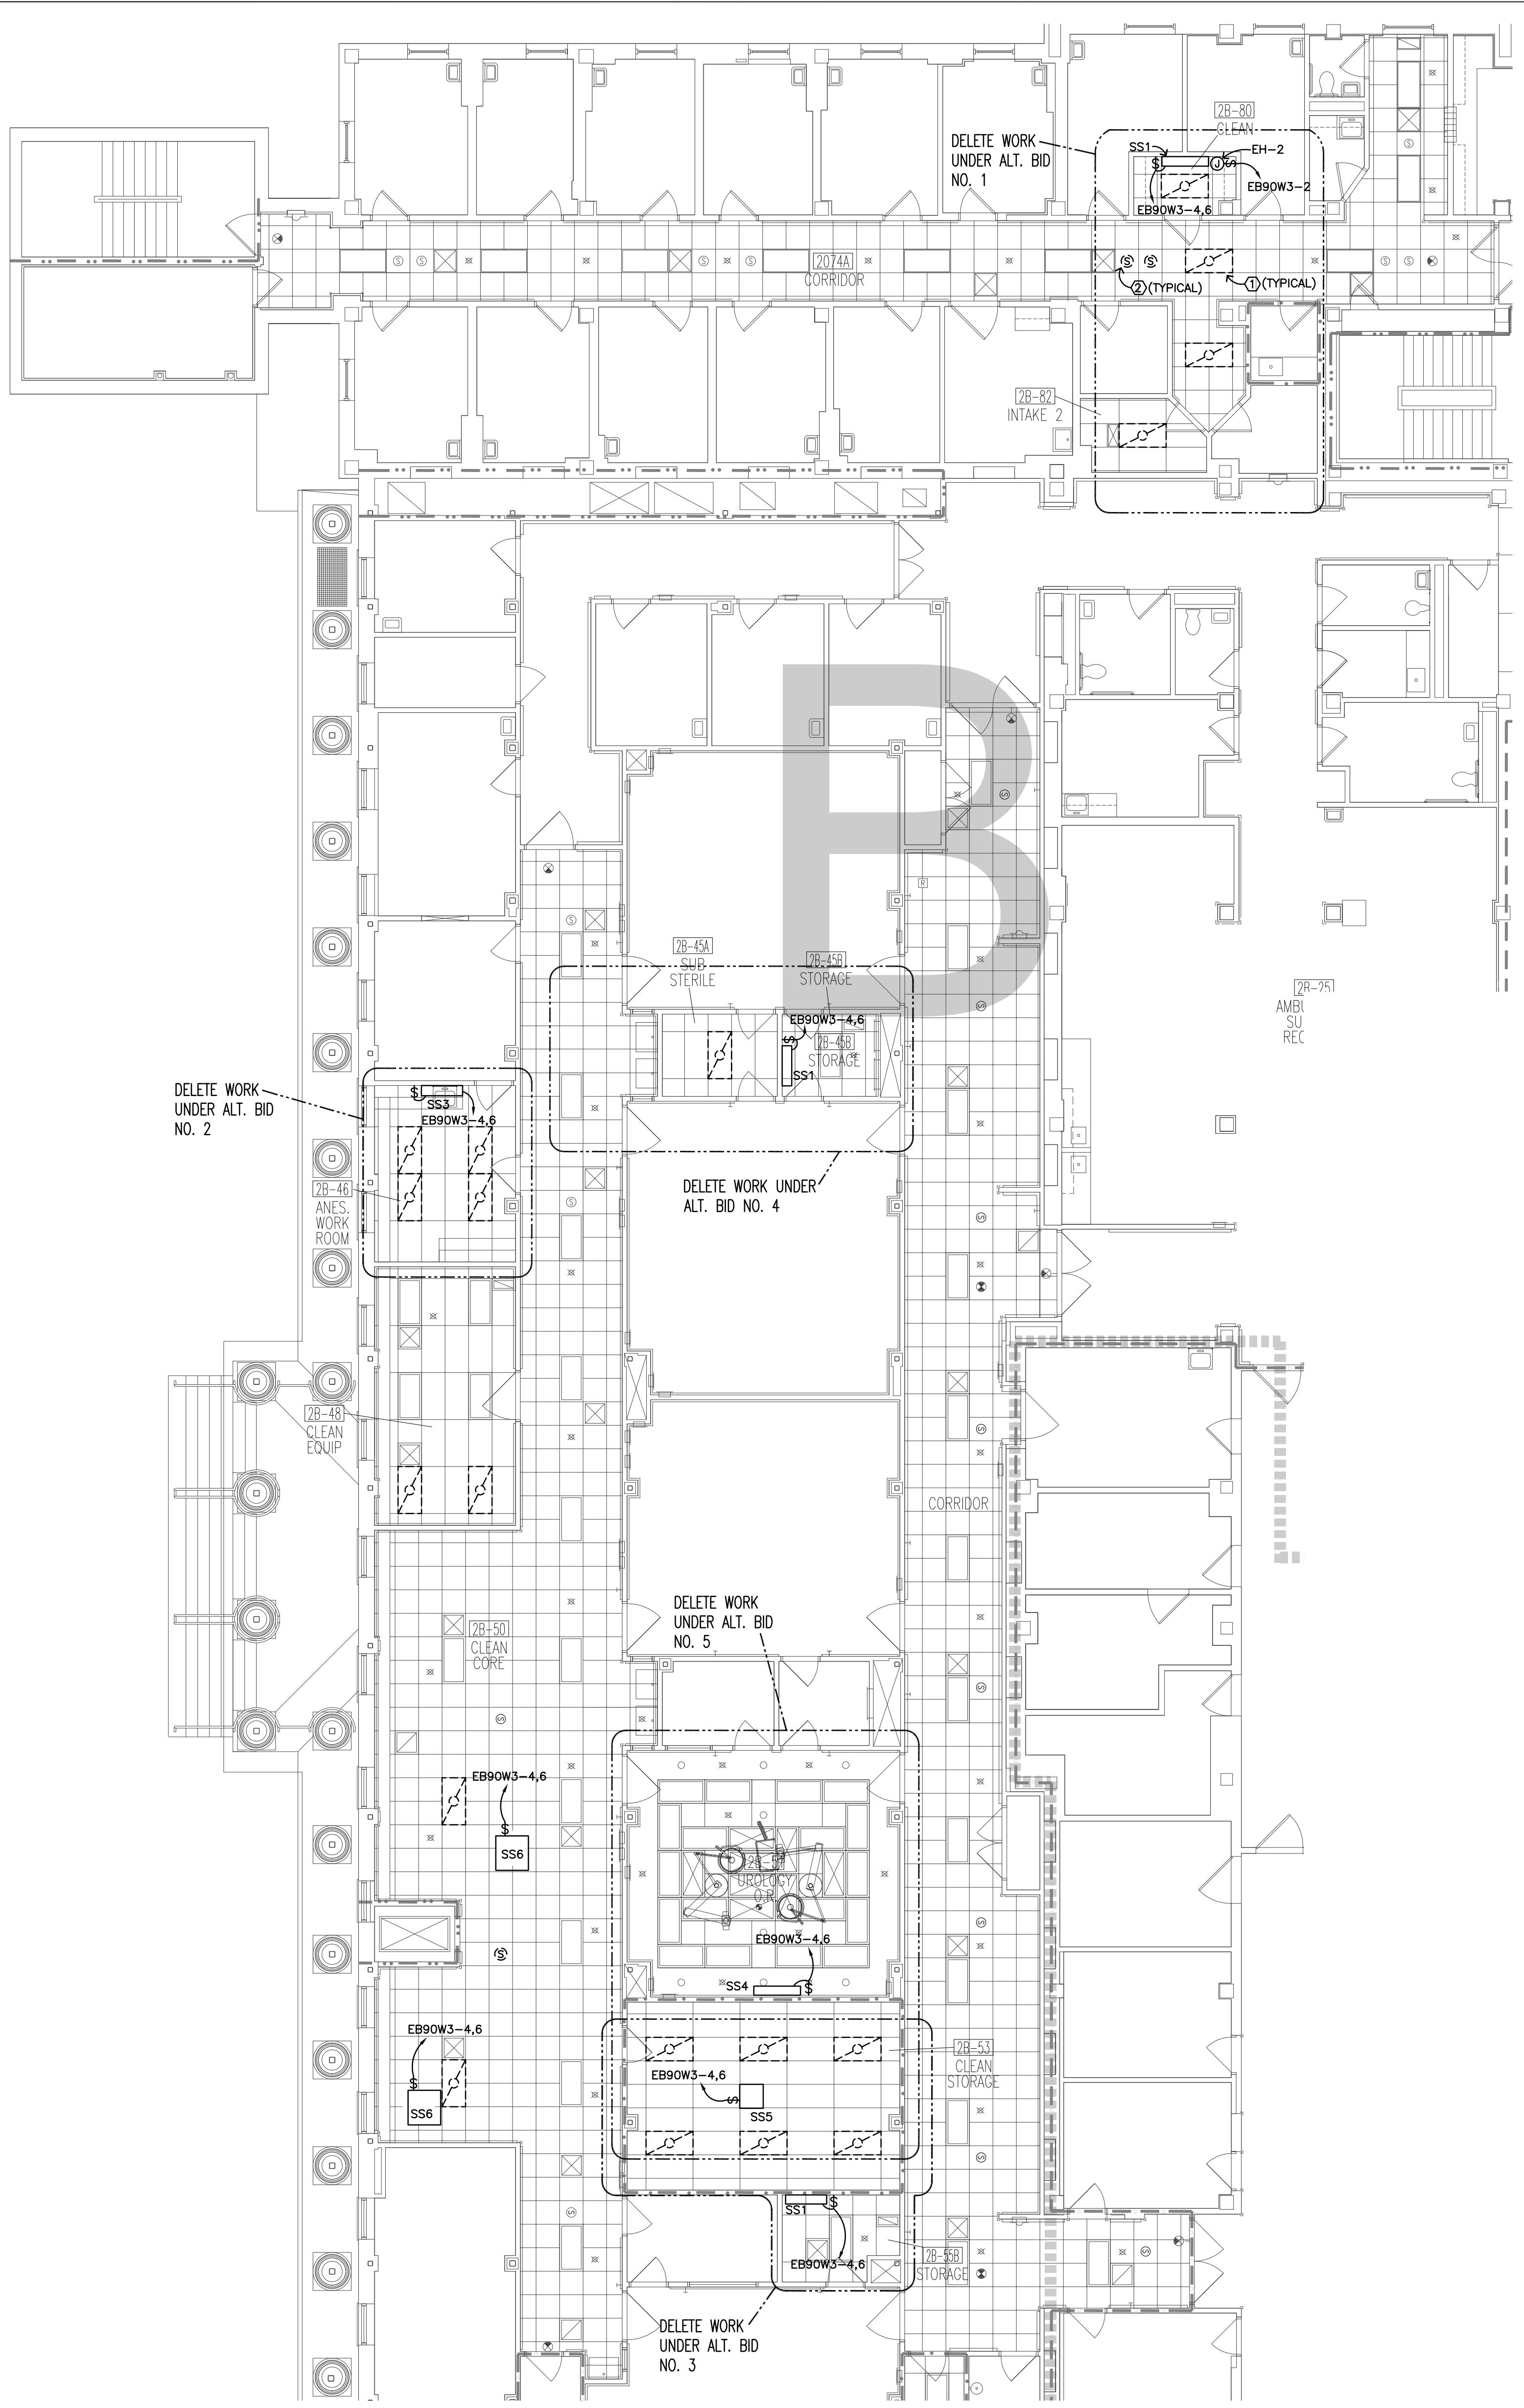


IMAGE GROUP INC.
403 CENTER AVENUE, SUITE 300
MOORHEAD, MN 56560


IMAGE GROUP INC., Architecture & Interiors
OBERMILLER NELSON ENGINEERING, Mechanical Engineers
MBN ENGINEERING, Electrical Engineers



Drawing Title		Project Title	
FIRST FLOOR ELECTRICAL PLAN - 'A', 'C' AND 'E' WINGS		IMPROVE SPS/LOGISTICS STORAGE ROOM HVAC SYSTEMS	
VA Project No.	Contract No.	Designed By	Date
437-13-103	VA263-P-1217 VA263-C-	MB	JULY 5, 2013
Building No.	AutoCAD File Name	Checked By	Scale:
1, 9, 46	13-027_E11_E12.dwg	TP	1/8" = 1'-0"
Location	FARGO VA HEALTH CARE SYSTEM FARGO, ND		



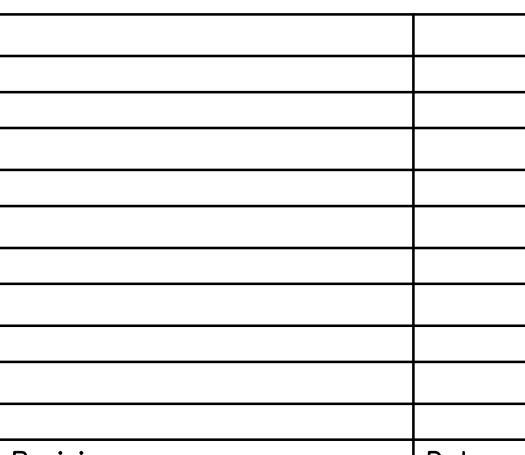
SECOND FLOOR ELECTRICAL PLAN - 'B' WING




**Dept. of Veterans Affairs
Health Care System
2101 Elm Street North
Fargo, ND 58102**



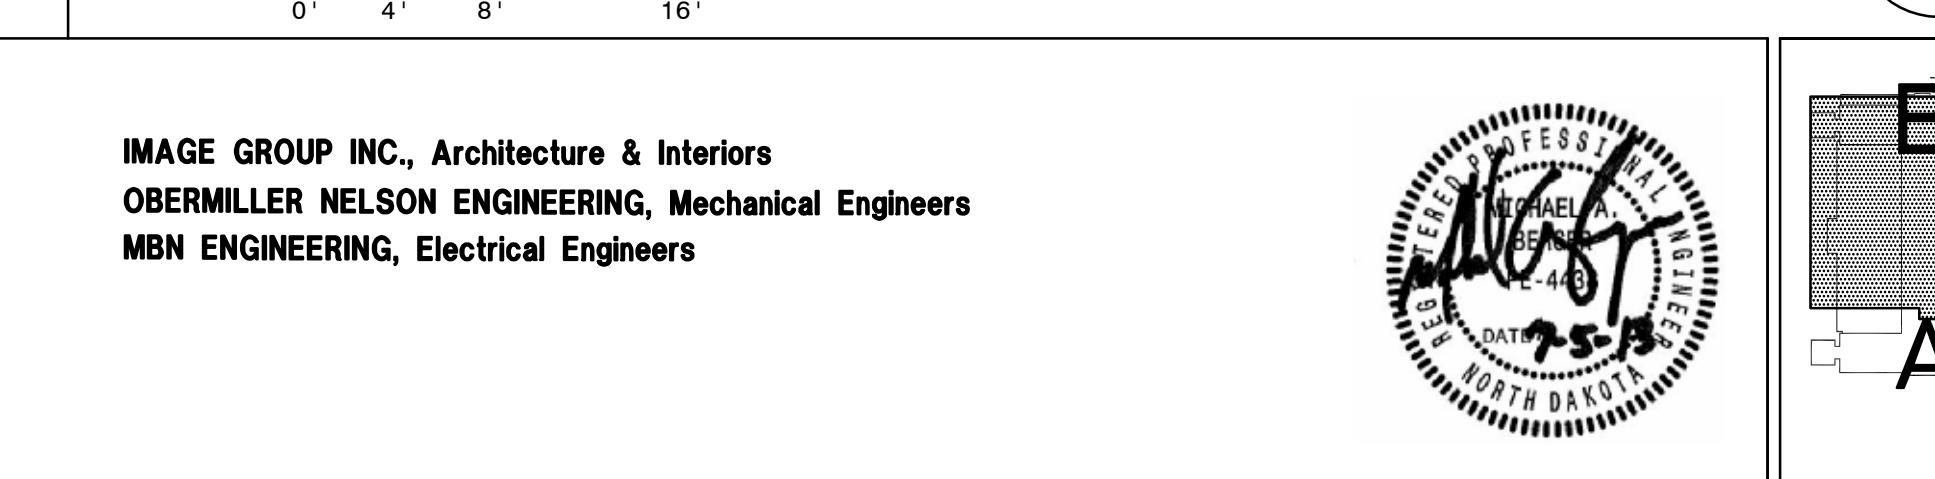IMAGE GROUP INC., Architecture & Interiors
OBERMILLER NELSON ENGINEERING, Mechanical Engineers
MBN ENGINEERING, Electrical Engineers



SECOND FLOOR ELECTRICAL PLAN - 'C' WING

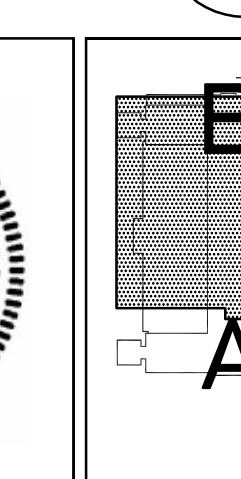



Drawing Title
SECOND FLOOR ELECTRICAL
PLAN - 'B' AND 'C' WINGS


Project Title

IMPROVE SPS/LOGISTICS STORAGE ROOM HVAC SYSTEMS

7	Designed By MB	Checked By MB	Drawn By TP
	Location FARGO VA HEALTH CARE SYSTEM FARGO, ND		

JULY 5, 2013

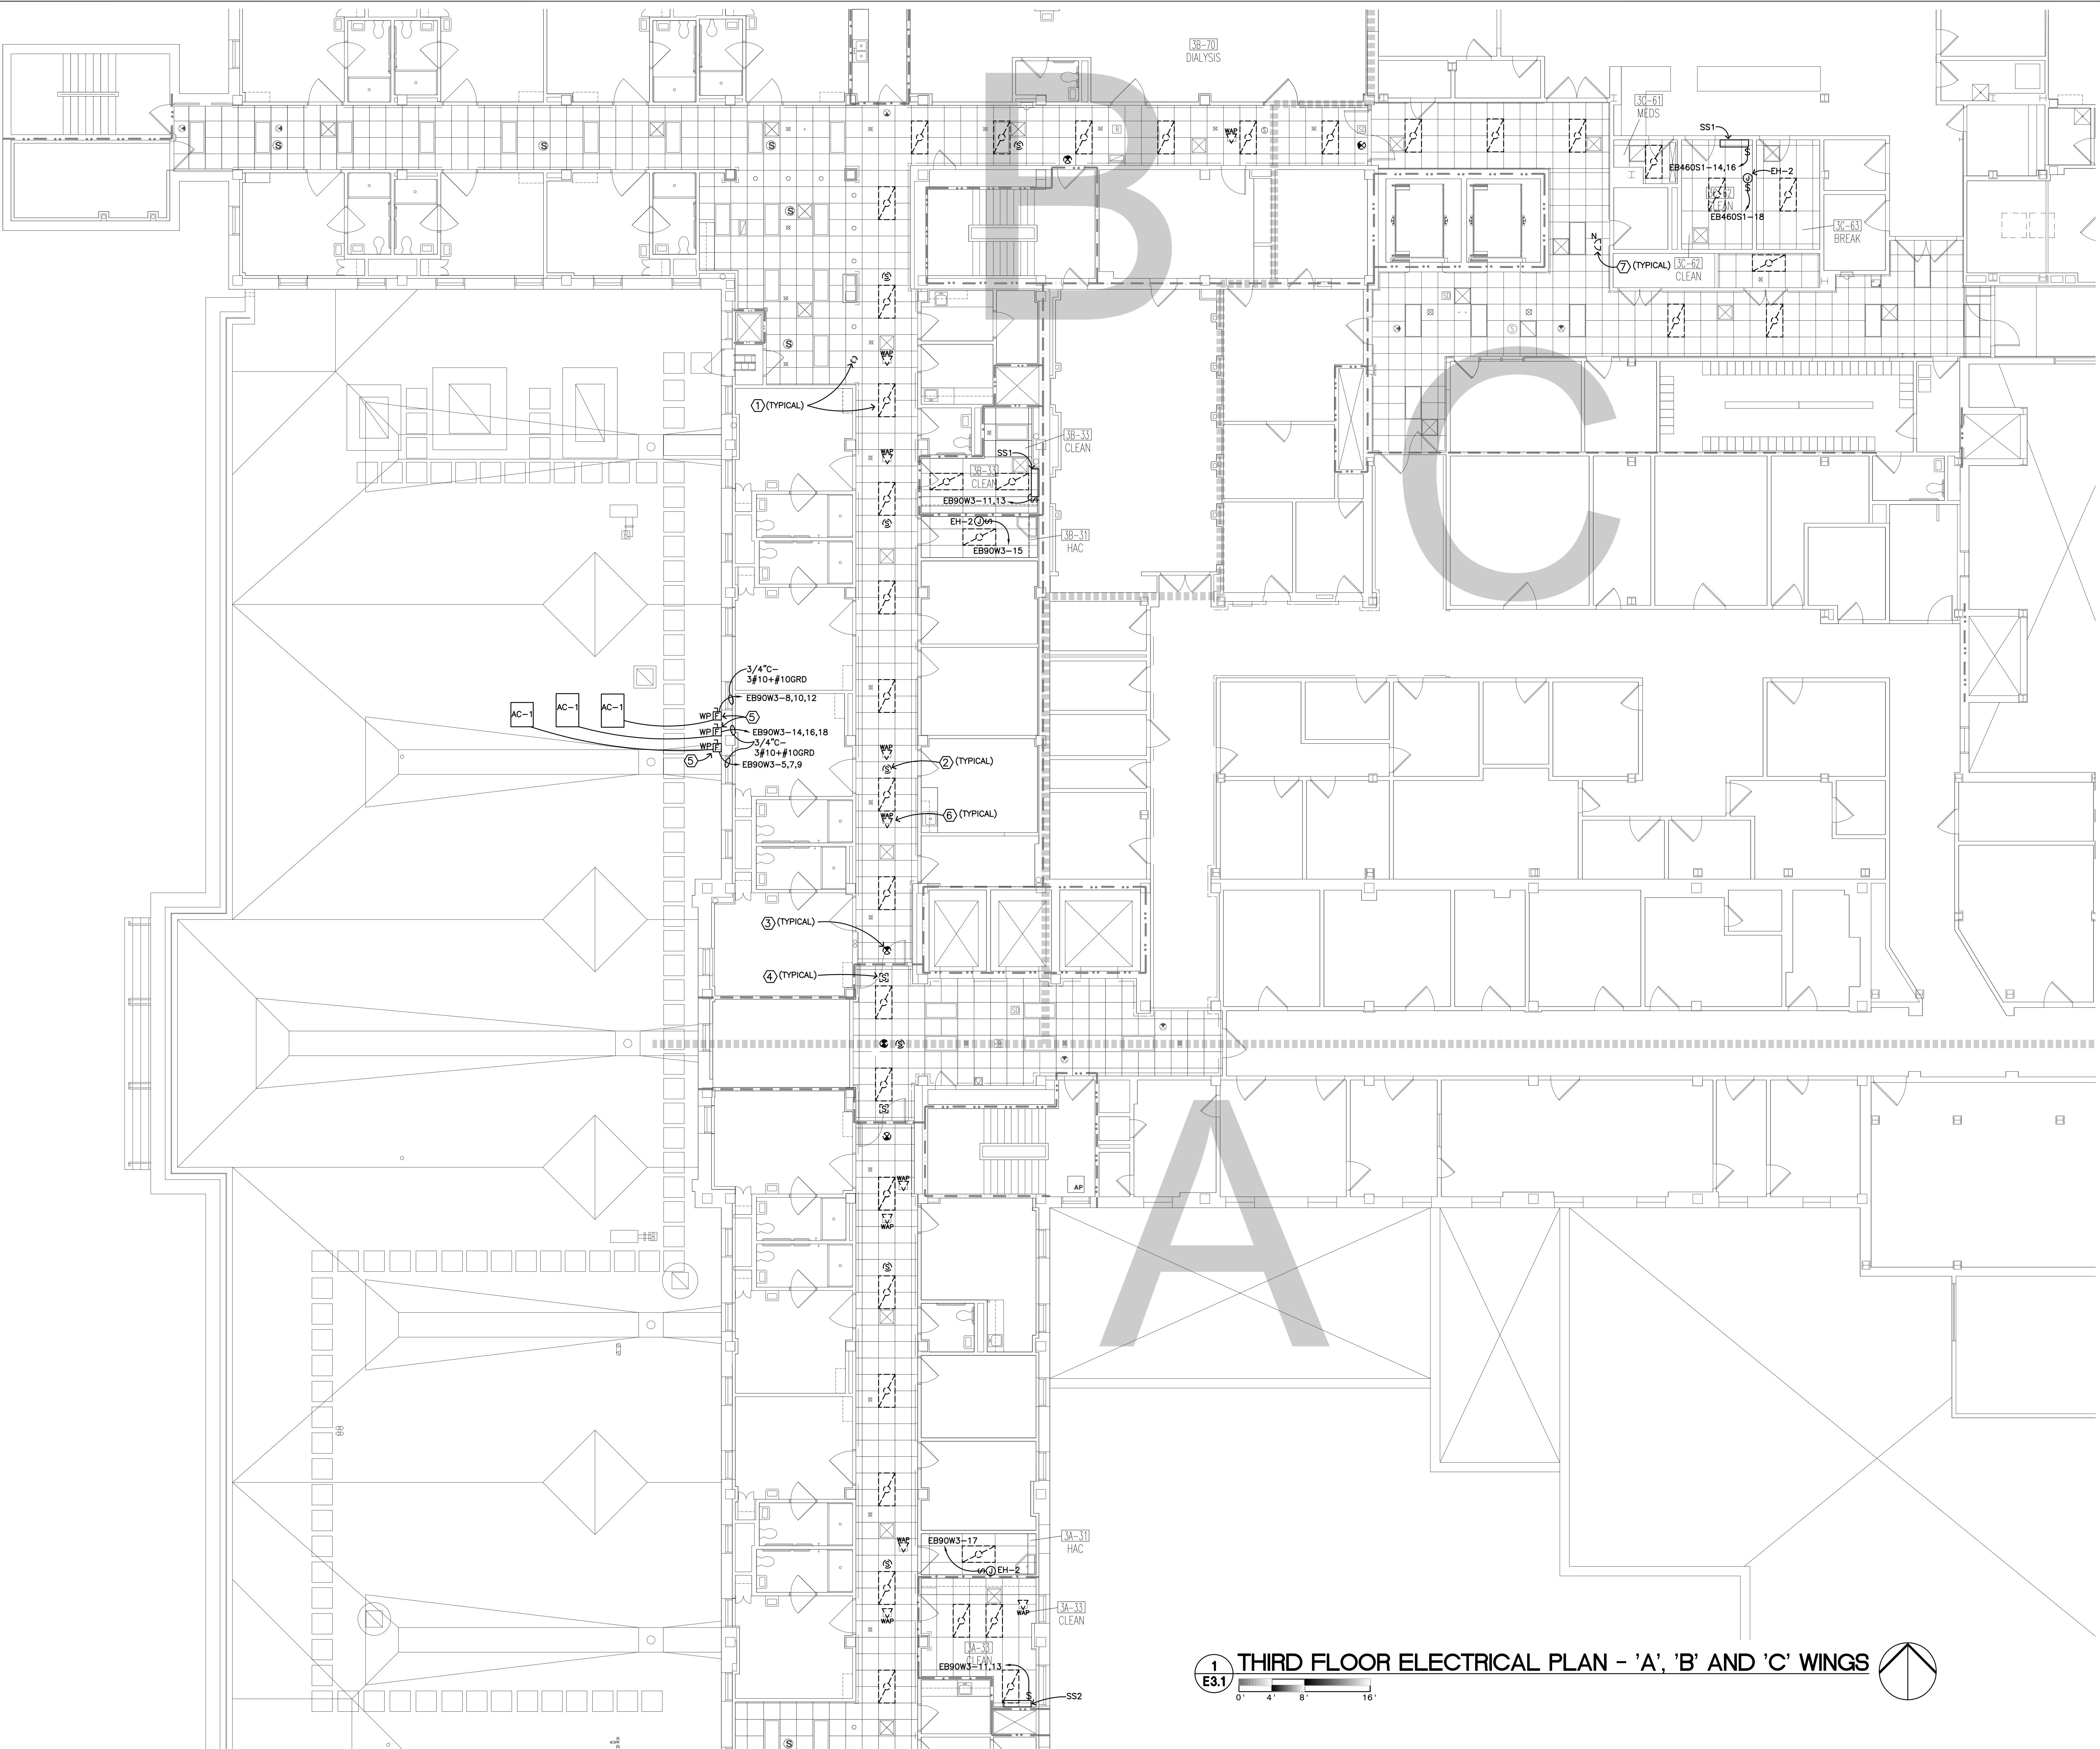1/8" = 1'-0"



1 THIRD FLOOR ELECTRICAL PLAN - 'A', 'B' AND 'C' WINGS


Revisions		Date



Dept. of Veterans Affairs
Health Care System
2101 Elm Street North
Fargo, ND 58102



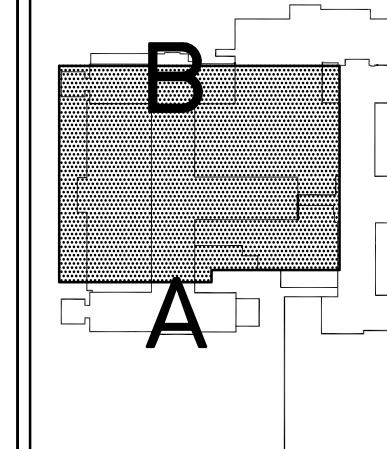IMAGE GROUP INC., Architecture & Interiors
OBERMILLER NELSON ENGINEERING, Mechanical Engineers
MBN ENGINEERING, Electrical Engineers




Drawing Title		Project Title		Date
THIRD FLOOR ELECTRICAL PLAN - 'A', 'B' AND 'C' WINGS		IMPROVE SPS/LOGISTICS	Storage Room HVAC Systems	JULY 5, 2013
VA Project No.	Contract No.	Building No.	AutoCAD File Name	Scale:
437-13-103	VA263-P-1217	1, 9, 46	13-027.E31.dwg	1/8" = 1'-0"

Designed By	Checked By	Drawn By	Date
MB	MB	TP	JULY 5, 2013
Dwg. No.			13-027.E31

Dwg. 19 of 21

PHASING NOTES:
 1. ALL WORK IN FIRST FLOOR ROOMS EXCEPT 1B-42 AND 1A-72 SHALL OCCUR DURING OVERTIME AND/OR WEEKEND HOURS. SPACES SHALL BE CLEAN AND RETAINED WORKING AREA FOR USE BY THE VA STAFF DURING NORMAL BUSINESS HOURS.
 2. CAREFULLY COORDINATE WITH THE OWNER A MINIMUM OF 2 WEEKS IN ADVANCE PRIOR TO WORK COMMENCING.
 3. REFER TO SHEET X1 GENERAL NOTES AND ARCHITECTURAL SHEETS FOR SPECIFIC PHASING INFORMATION FOR INDIVIDUAL SPACES.

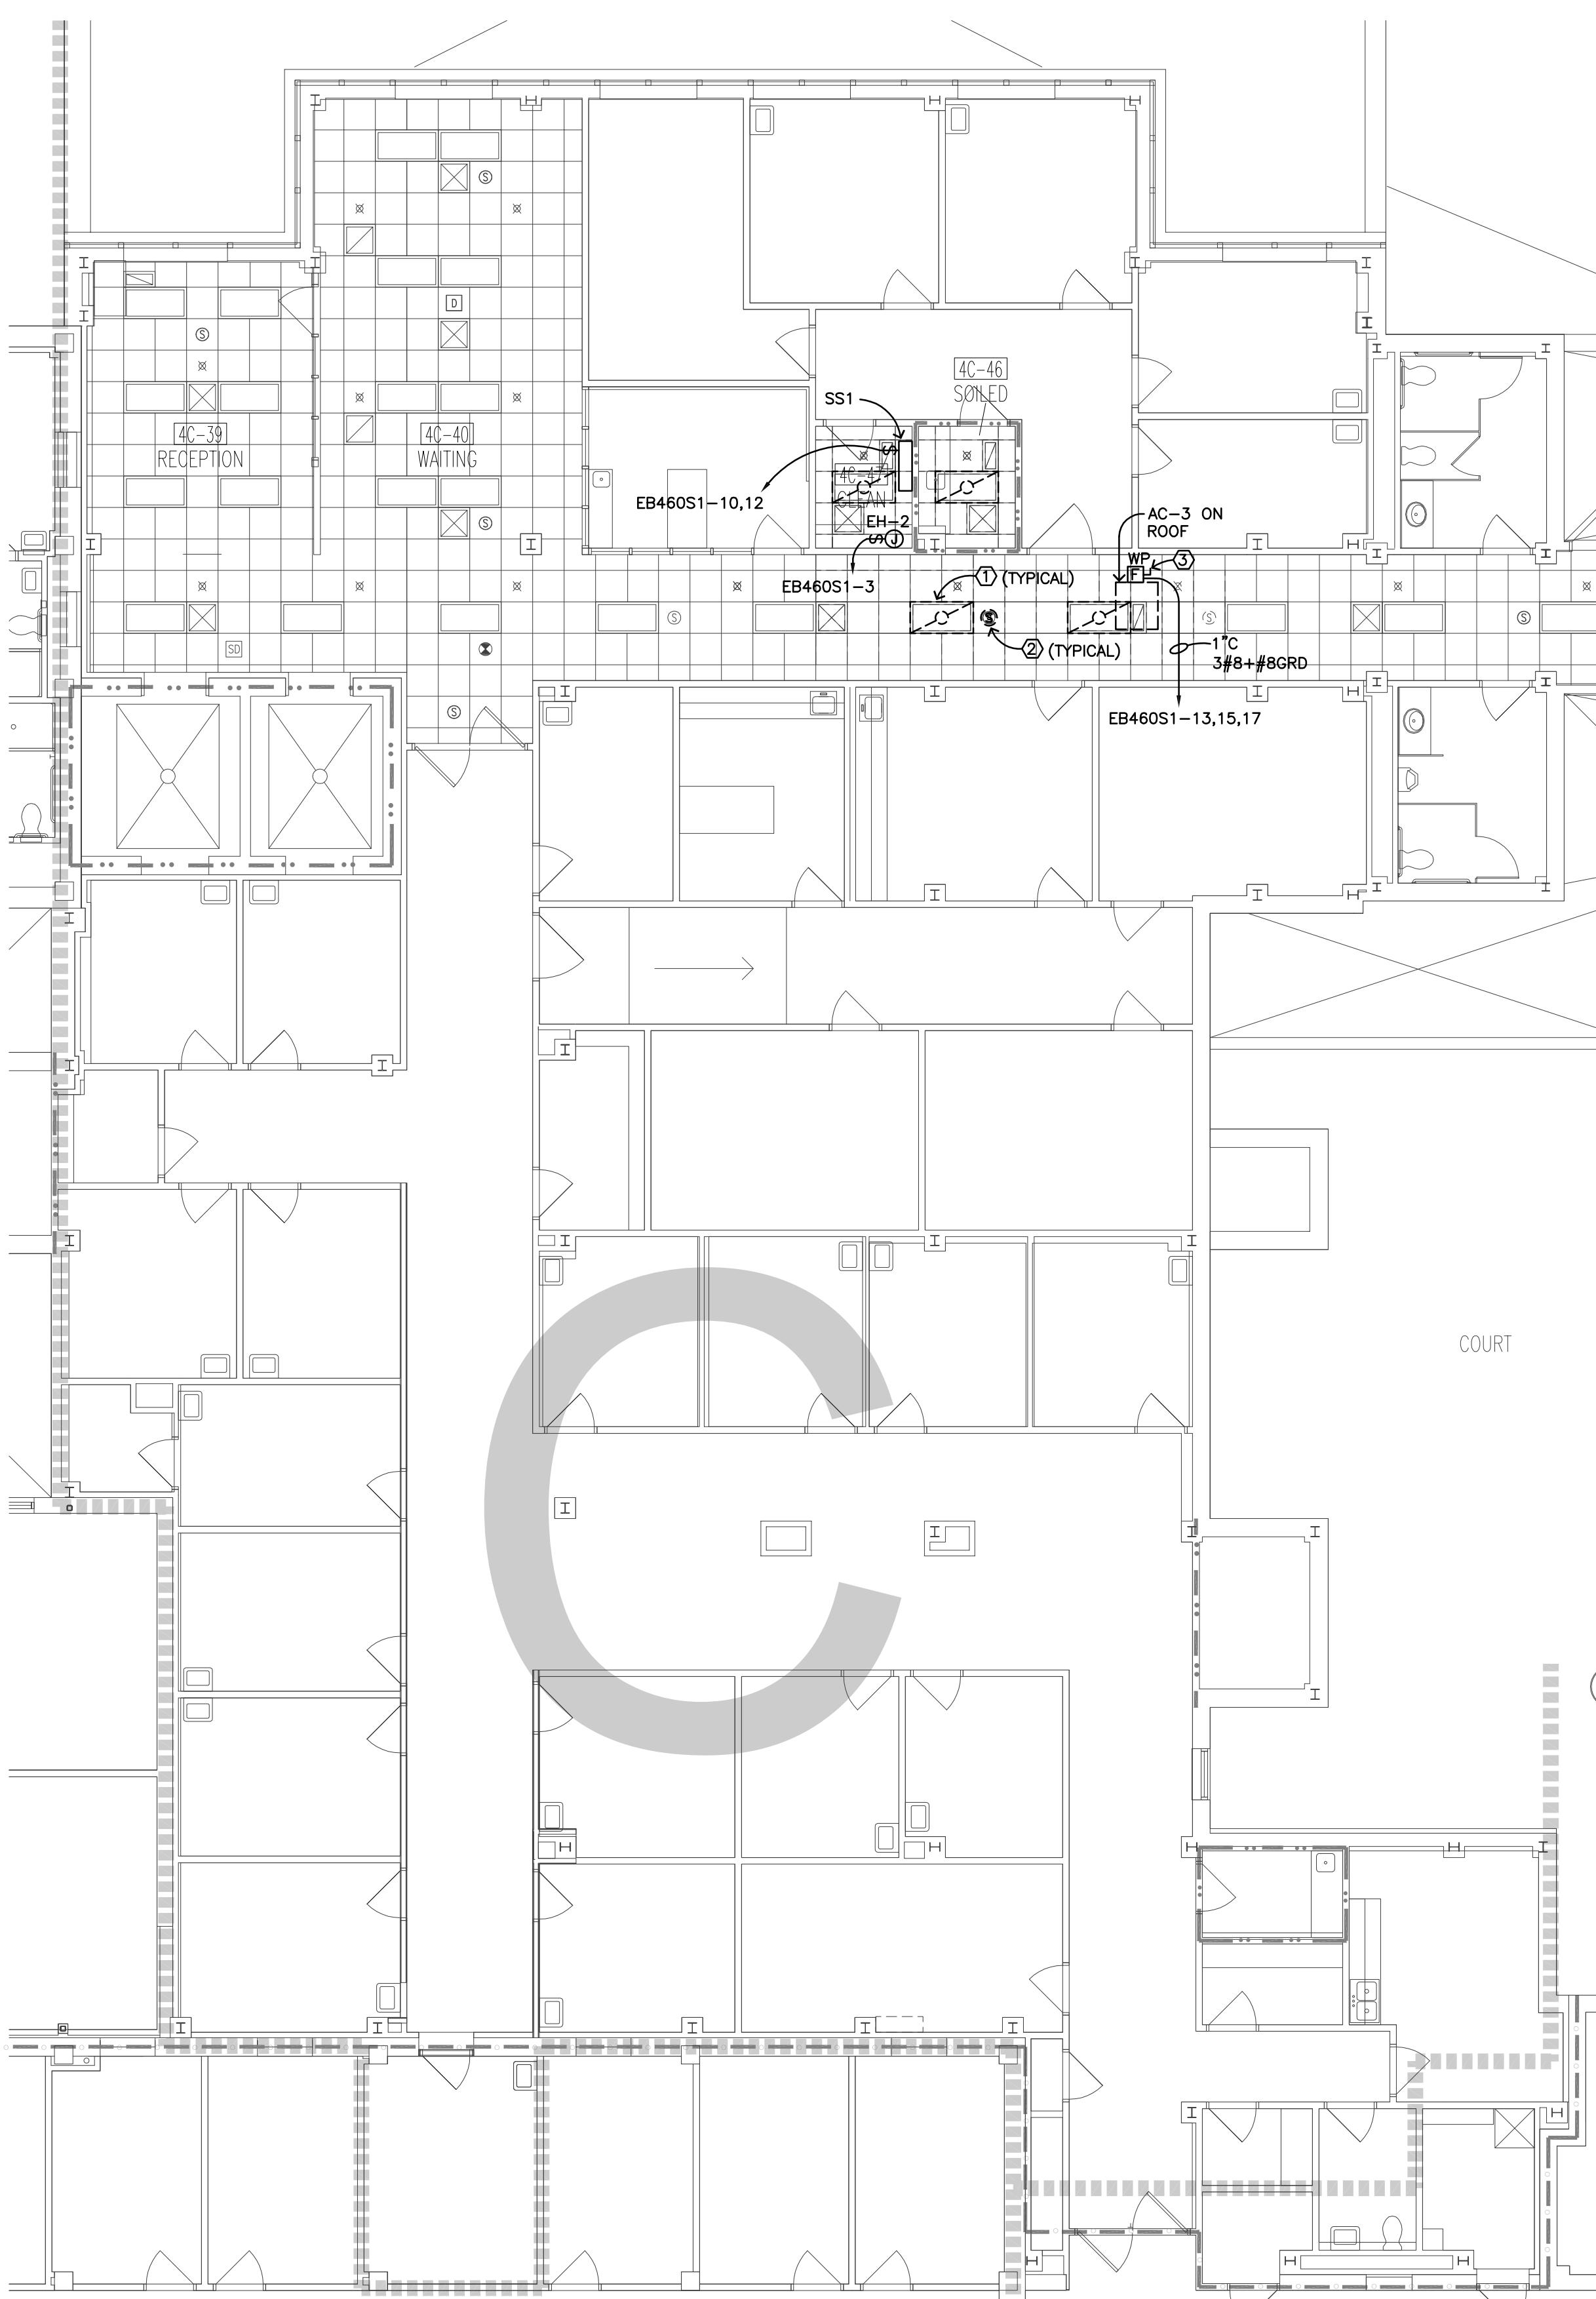PLAN NOTES:
 ① DISCONNECT AND REMOVE EXISTING LIGHT FIXTURE. FIXTURE TO BE REINSTALLED WHERE SHOWN UPON COMPLETION OF CEILING INSTALLATION.
 ② DISCONNECT AND REMOVE EXISTING SPEAKER. SPEAKER TO BE REINSTALLED UPON COMPLETION OF CEILING INSTALLATION.
 ③ DISCONNECT AND REMOVE EXISTING EXIT LIGHT FIXTURE. FIXTURE TO BE REINSTALLED UPON COMPLETION OF CEILING INSTALLATION.
 ④ DISCONNECT AND REMOVE EXISTING ELECTRIC DOOR LOCK. DOOR LOCK TO BE REINSTALLED UPON COMPLETION OF CEILING INSTALLATION.
 ⑤ PROVIDE A WEATHERPROOF 20 AMP FUSIBLE DISCONNECT FUSED AT 40 AMPS.
 ⑥ DISCONNECT AND REMOVE EXISTING SPEAKER. SPEAKER TO BE REINSTALLED UPON COMPLETION OF CEILING INSTALLATION.
 ⑦ DISCONNECT AND REMOVE EXISTING NURSE CALL DEVICE. DEVICE TO BE REINSTALLED UPON COMPLETION OF CEILING INSTALLATION.



1
E4.1
FOURTH FLOOR ELECTRICAL PLAN - 'C' WING
0' 4' 8' 16'

PHASING NOTES:

- ALL WORK IN FIRST FLOOR ROOMS EXCEPT 1B-42 AND 1A-72 SHALL OCCUR DURING OVERTIME AND/OR WEEKEND HOURS. SPACES SHALL BE CLEANED AND RETURNED TO WORKING CONDITION BY THE VA STAFF DURING NORMAL BUSINESS HOURS.
- CAREFULLY COORDINATE WITH THE OWNER A MINIMUM OF 2 WEEKS IN ADVANCE PRIOR TO WORK COMMENCING.
- REFER TO SHEET X1 GENERAL NOTES AND ARCHITECTURAL SHEETS FOR SPECIFIC PHASING INFORMATION FOR INDIVIDUAL SPACES.

PLAN NOTES:

- ① DISCONNECT AND REMOVE EXISTING LIGHT FIXTURE TO BE REINSTALLED WHERE SHOWN UPON COMPLETION OF CEILING INSTALLATION.
- ② DISCONNECT AND REMOVE EXISTING SPEAKER. SPEAKER TO BE REINSTALLED UPON COMPLETION OF CEILING INSTALLATION.
- ③ PROVIDE A WEATHERPROOF 20 AMP FUSIBLE DISCONNECT FUSED AT 40 AMPS.

Revisions	Date




Dept. of Veterans Affairs
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2101 Elm Street North
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IMAGE GROUP INC.
403 CENTER AVENUE, SUITE 300
MOORHEAD, MN 56560

IMAGE GROUP INC., Architecture & Interiors
OBERMILLER NELSON ENGINEERING, Mechanical Engineers
MBN ENGINEERING, Electrical Engineers



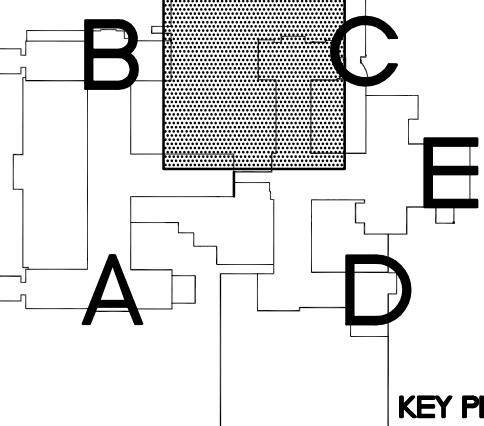Drawing Title:
FOURTH FLOOR ELECTRICAL PLAN
- 'C' WING
Project Title:
IMPROVE SPS/LOGISTICS
STORAGE ROOM HVAC SYSTEMS
VA Project No. 437-13-103 **Contract No.** VA263-P-1217
Building No. 1, 9, 46 **AutoCAD File Name** 13-027 E4.1.dwg

Designed By: MB **Checked By:** MB **Drawn By:** TP
Location: FARGO VA HEALTH CARE SYSTEM
FARGO, ND
Drawing No.: E4.1

Date: JULY 5, 2013
Scale: 1/8" = 1'-0"
Dwg. No.: 20 of 21
Department of: Veterans Affairs

PANELBOARD LOAD SCHEDULE											
PANEL:	MAIN:			ENCLOSURE:			LOCATION:				
RATING:	AIC RATING:			VOLTS:			NEMA 1				
CKT #	TRIP POLE	LOAD IN VOLT-AMPERES	LOAD DESCRIPTION	PH	LOAD IN VOLT-AMPERES	LOAD DESCRIPTION	PH	LOAD IN VOLT-AMPERES	LOAD DESCRIPTION	PH	CKT #
1	20 1	1900	1C-45A SS	A	42	42	B	15	15	C	2
3	20 1	1900	AC-40 EH-2	B	42	42	C	2	4		
5	50 1	7740	2C-49 SS	A	42	42	B	15	6		
7	1	7740	A	B	42	42	C	2	8		
9	3	7740	B	C	42	42	A	15	10		
11	20 1	1900	2C-49 EH-2	C	42	42	A	2	12		
13	35	3600	AC-3	A	42	42	B	15	14		
15	3	3600	ON ROOF	B	42	42	C	2	16		
17	3	3600	C	3C-62 EH-2	1900		A	20	1	18	
19	20 1			A			B	20	1	20	
21	20 1			B			C	20	1	22	
23	20 1			C			A	20	1	24	
25	20 1			A			B	20	1	26	
27	20 1			B			C	20	1	28	
29	20 1			C			A	20	1	30	
31	20 1			A			B	20	1	32	
33	20 1			B			C	20	1	34	
35	20 1			C			A	20	1	36	
37	20 1			A			B	20	1	38	
39	20 1			B			C	20	1	40	
41	20 1			C			A	20	1	42	
LOAD CALCULATIONS											
LOAD TYPE	A	B	C	TOTAL VA	Demand Factor	Diversified Load	NOTES:				
LIGHTING	0	0	0	1	0	0					
RECEPTACLES	0	0	0	0	0.50	0					
MOTORS & EQUIP.	13366	13366	15224	41956	0.90	37760					
KITCHEN EQUIP.	0	0	0	0	0.65	0					
HEAT / AC	0	0	0	0	0.90	0					
LARGEST MOTOR					0.25	0					
TOTAL AMPS:	105			TOTAL VA:	37,760						

PANELBOARD LOAD SCHEDULE											
PANEL:	MAIN:			ENCLOSURE:			LOCATION:				
RATING:	AIC RATING:			VOLTS:			NEMA 1				
CKT #	TRIP POLE	LOAD IN VOLT-AMPERES	LOAD DESCRIPTION	PH	LOAD IN VOLT-AMPERES	LOAD DESCRIPTION	PH	LOAD IN VOLT-AMPERES	LOAD DESCRIPTION	PH	CKT #
1	15	300	BB-15,24 SS	A	1900	BB-80 EH-2	B	1900	BB-80 SS	C	2
3	20 1	300	AC-1 ROOF	B	600	BB-80 SS	C	600	AC-1 ROOF	A	4
5	35	3600	AC-1 ROOF	A	3600	AC-1 ROOF	B	3600	AC-1 ROOF	C	6
7	3	3600	AC-1 ROOF	B	3600	AC-1 ROOF	C	3600	AC-1 ROOF	A	8
9	3	3600	3B-33 SS	A	3600	3B-31 EH-2	B	3600	3B-31 EH-2	C	10
11	15	85	3B-31 EH-2	B	3600	3A-31 EH-2	C	3600	3A-31 EH-2	A	12
13	20 1	85	3A-31 EH-2	C	3600	3A-31 EH-2	A	3600	3A-31 EH-2	B	14
15	20 1	1900	3A-31 EH-2	A	3600	3A-31 EH-2	B	3600	3A-31 EH-2	C	16
17	20 1	1900	3A-31 EH-2	B	3600	3A-31 EH-2	C	3600	3A-31 EH-2	A	18
19	20 1	1900	3A-31 EH-2	C	3600	3A-31 EH-2	A	3600	3A-31 EH-2	B	20
21	20 1			B			C			A	22
23	20 1			C			A			B	24
25	20 1			A			B			C	26
27	20 1			B			C			A	28
29	20 1			C			A			B	30
31	20 1			A			B			C	32
33	20 1			B			C			A	34
35	20 1			C			A			B	36
37	20 1			A			B			C	38
39	20 1			B			C			A	40
41	20 1			C			A			B	42
LOAD CALCULATIONS											
LOAD TYPE	A	B	C	TOTAL VA	Demand Factor	Diversified Load	NOTES:				
LIGHTING	0	0	0	1	0	0					
RECEPTACLES	0	0	0	0	0.50	0					
MOTORS & EQUIP.	13085	13085	13385	40070	0.90	36063					
KITCHEN EQUIP.	0	0	0	0	0.65	0					
HEAT / AC	0	0	0	0	0.90	0					
LARGEST MOTOR					0.25	0					
TOTAL AMPS:	100			TOTAL VA:	36,063						

PANELBOARD LOAD SCHEDULE											
PANEL:	MAIN:			ENCLOSURE:			LOCATION:				
RATING:	AIC RATING:			VOLTS:			NEMA 1				
CKT #	TRIP POLE	LOAD IN VOLT-AMPERES	LOAD DESCRIPTION	PH	LOAD IN VOLT-AMPERES	LOAD DESCRIPTION	PH	LOAD IN VOLT-AMPERES	LOAD DESCRIPTION	PH	CKT #
1	15	1900	BE-09 EH-1	A	1900	BE-50 SS	B	1900	BE-50 SS	C	2
3	20 1	1900	2C-90 EH-2	B	1900						